

175 MCGLONE ROAD, DROUIN

DETAILED DESIGN - STAGE 4

BAW BAW SHIRE COUNCIL - PLA0382/16

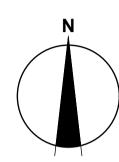

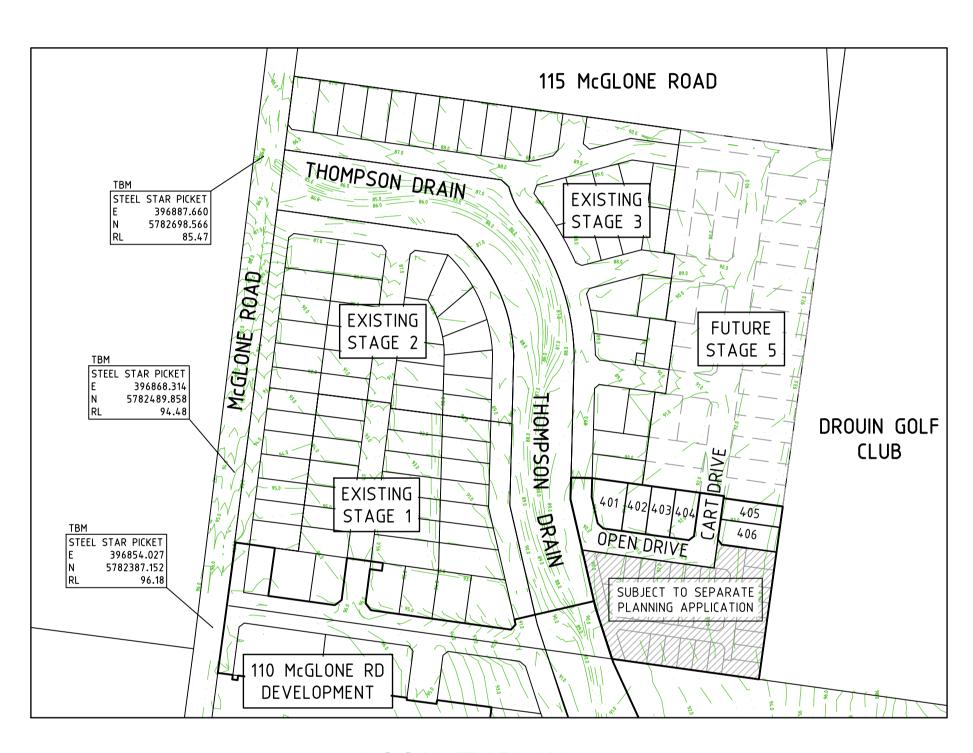

LOCALITY PLAN
VIC ROADS REF: 96 F3

Drawing Index

Drawing mue	<u>X</u>	
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16028-04-02	Layout Plan	
16028-04-03	Intersection Detail Plan & Typical Cross Sections	
16028-04-04	Longitudinal Sections & Setout Information	
16028-04-05	Cross Sections - Open Drive	CH0.000 - CH80.231
16028-04-06	Cross Sections - Open Drive & Cart Drive	
16028-04-07	Drainage Longitudinal Sections	
16028-04-08	Pit Schedule	
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16028-04-10	Master Services Plan	
16028-04-11	Signage & Linemarking Plan	
16028-04-12	Retaining Wall & Earthworks Plan	

THE FAIRWAYS

Principal


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——O/H E—— EXISTING ELECTRICITY (OVERHEAD) ——Ex G—— EXISTING GAS ——Ex T—— EXISTING TELSTRA ---Ex W--- EXISTING WATER ——EX RM—— EXISTING RISING MAIN ---EX RW--- EXISTING RECYCLED WATER Ex D— EXISTING STORMWATER DRAIN O—Ex S— EXISTING SEWER ---- EXISTING HOUSE DRAIN ---> ---> EXISTING SWALE DRAIN 141.34 EXISTING SURFACE LEVEL FS140.35 FINISHED BUILDING LINE LEVEL FR157.40 FINISHED RIDGE LINE LEVEL TW159.30 TOP OF RETAINING WALL BW159.30 BOTTOM OF RETAINING WALL RETAINING WALL — — ZERO LOT LINES PAVEMENT TREATMENT STRUCTURAL FILL > 200mm DEEP EX. STRUCTURAL FILL > 200mm DEEP □□⇒ DIRECTION OF FALL OVERLAND FLOW * ALLOTMENT TO BE GRADED EVENLY IN DIRECTION OF FALL TO LEVELS INDICATED CONCRETE EDGE STRIP WITH SUBSOIL DRAIN, "NO ROAD" SIGN & BARRIER → LIMIT OF WORKS EXISTING TREE TO BE RETAINED/REMOVED PERMANENT SURVEY MARK TEMPORARY BENCH MARK PROPOSED DRIVEWAY → PROPOSED STREET LIGHT

LEGEND - LAYOUT PLAN

────── SWALE DRAIN

− − −H HOUSE DRAIN

——GW— SERVICE CONDUITS

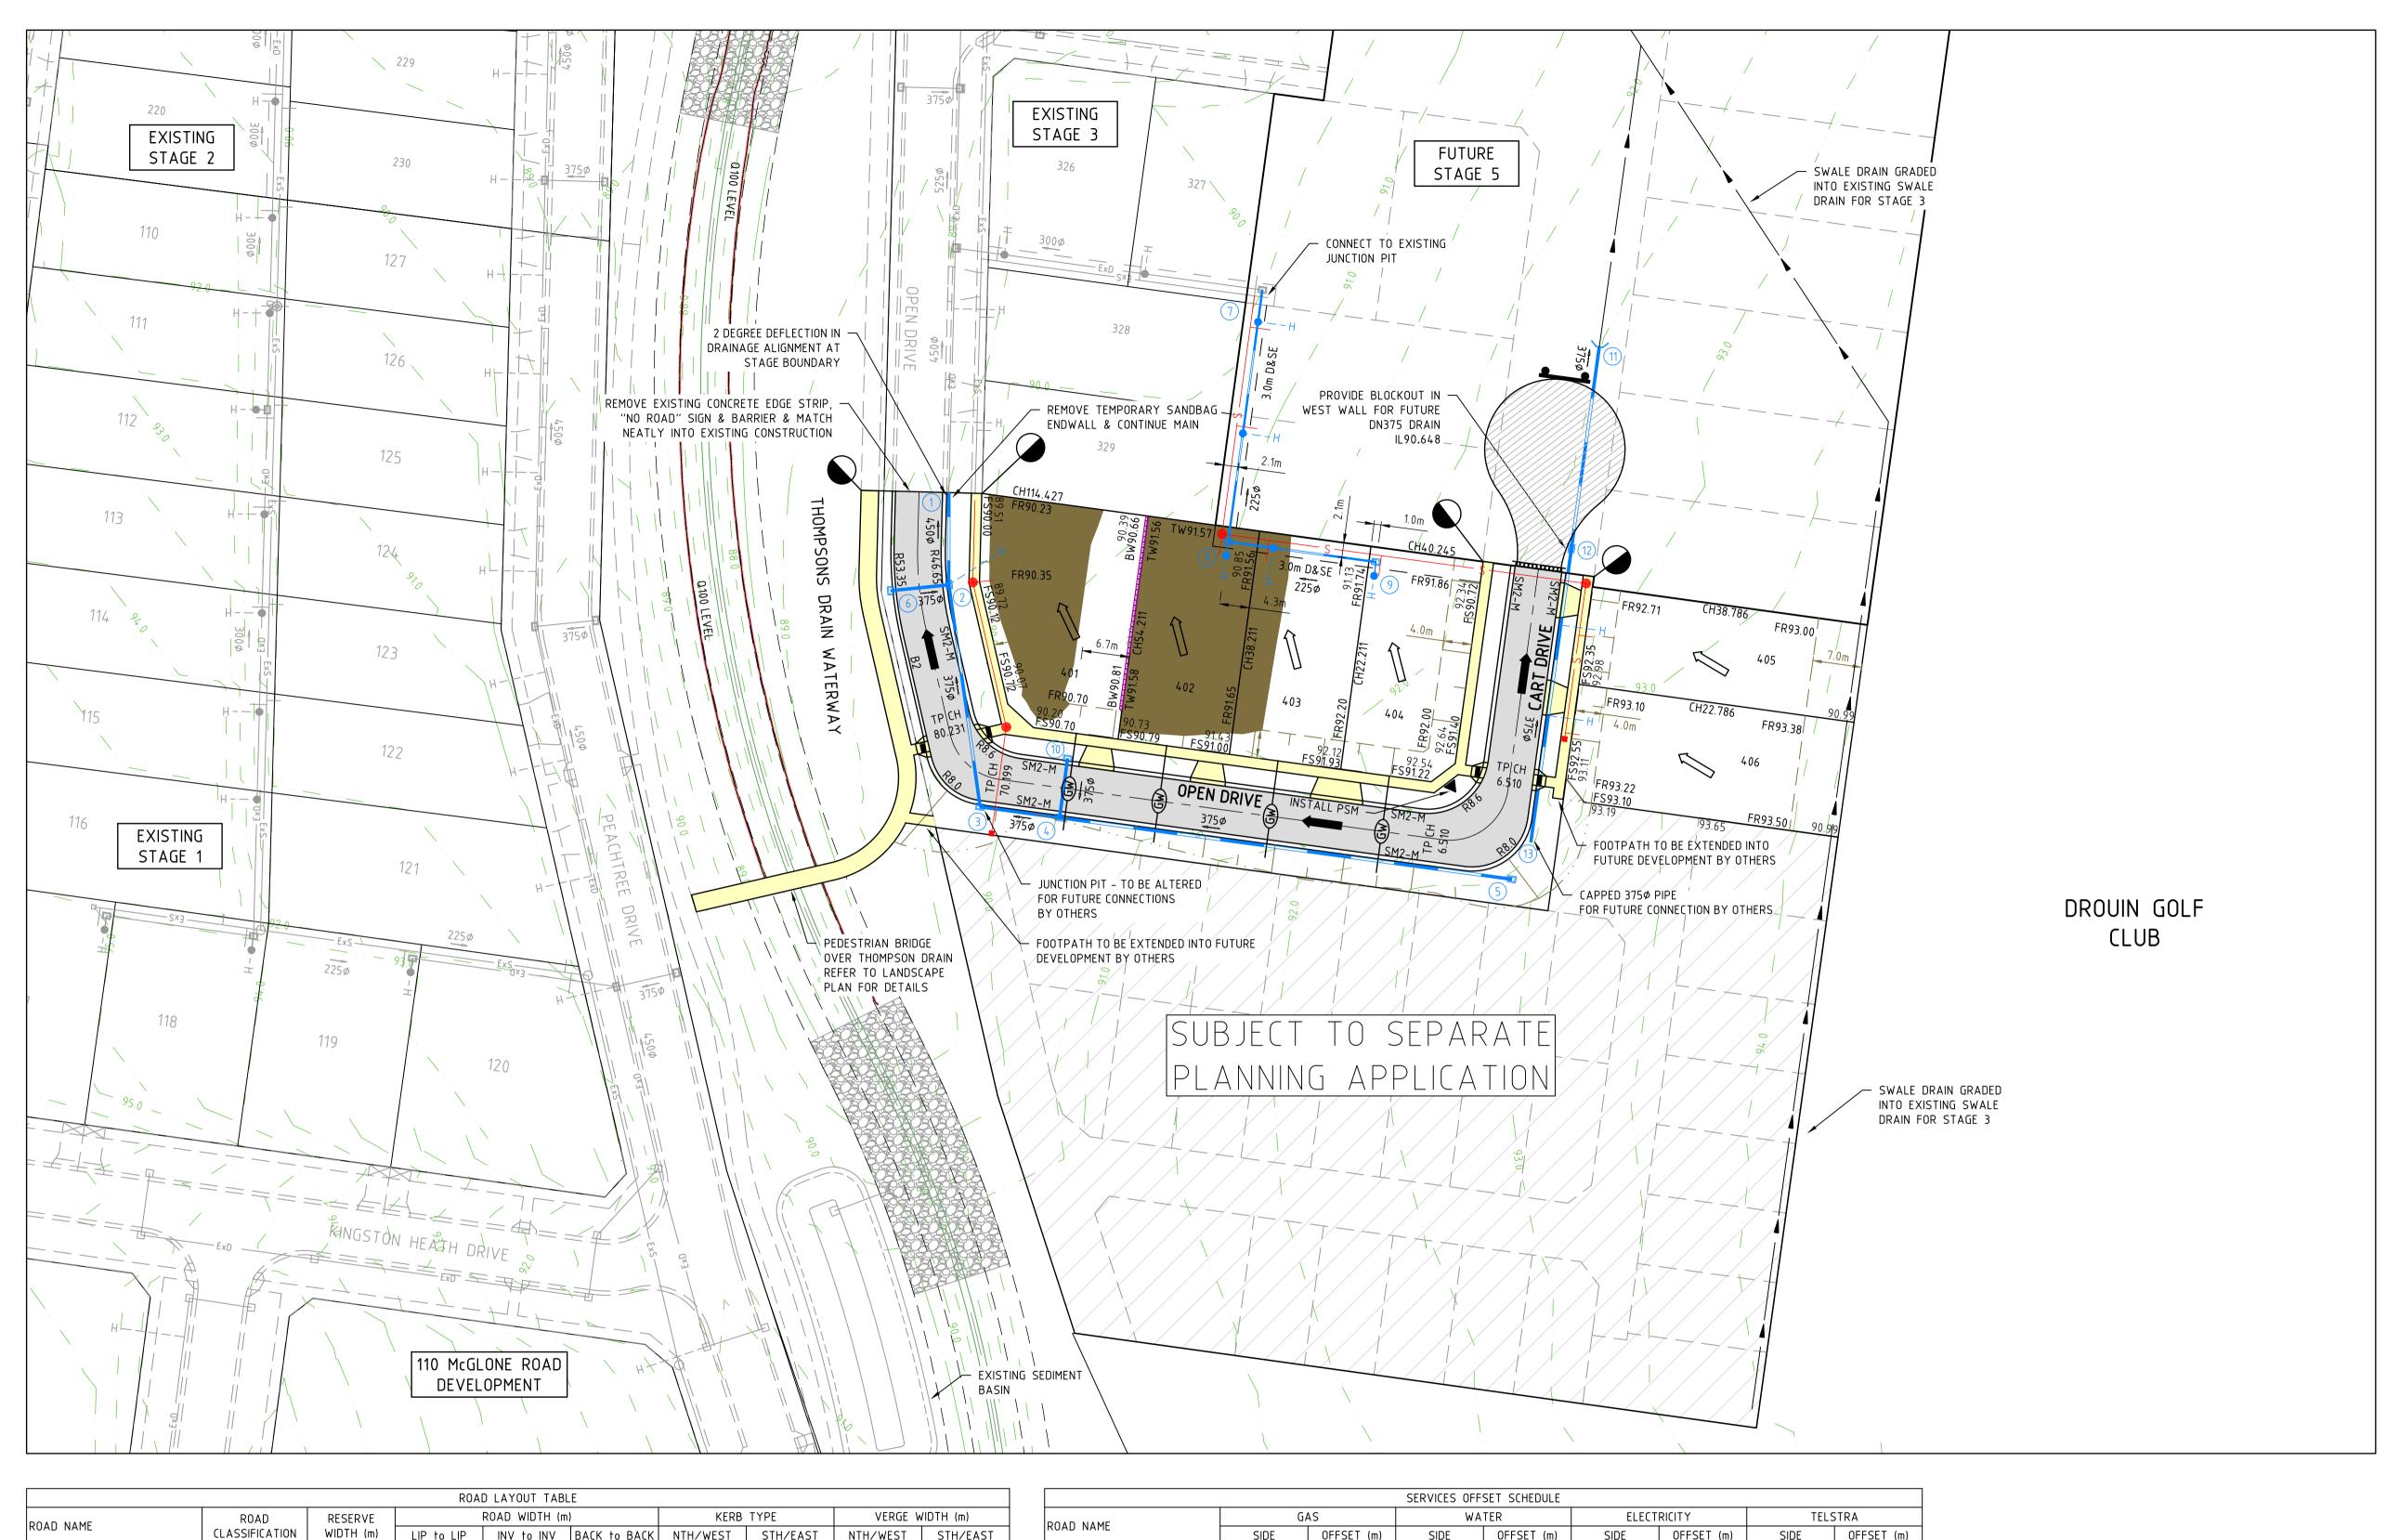TACTILE PAVERS

STORMWATER DRAIN, PIT & PROPERTY INLET

● S SEWER & MAINTENANCE STRUCTURES

----Ex E---- EXISTING ELECTRICITY (UNDERGROUND)

ROAD LAYOUT TABLE												
ROAD NAME	ROAD	RESERVE		ROAD WIDTH (m)	KERB	TYPE	VERGE WIDTH (m)				
ROAD NAME	CLASSIFICATION	WIDTH (m)	LIP to LIP	INV to INV	BACK to BACK	NTH/WEST	STH/EAST	NTH/WEST	STH/EAST			
OPEN DRIVE (LOT 401)	ACCESS ROAD	14.00	6.70	7.30	7.75	B2	SM2-M	1.20	5.05			
OPEN DRIVE (LOT 401-404)	ACCESS ROAD	16.00	6.70	7.30	7.90	SM2-M	SM2-M	4.05	4.05			
CART DRIVE (LOT 405-406)	ACCESS ROAD	16.00	6.70	7.30	7.90	SM2-M	SM2-M	4.05	4.05			

			SERVICES OFF	SET SCHEDULE				
DOAD NAME	G	AS	WATER		ELECTRICITY		TELSTRA	
ROAD NAME	SIDE	OFFSET (m)	SIDE	OFFSET (m)	SIDE	OFFSET (m)	SIDE	OFFSET (m)
OPEN DRIVE (LOT 401)	EAST	1.80	EAST	2.30	EAST	3.30	EAST	2.80
OPEN DRIVE (LOT 401-404)	SOUTH	2.10	SOUTH	2.60	NORTH	2.30	NORTH	1.80
CART DRIVE (LOT 405-406)	EAST	2.10	EAST	2.60	WEST	2.30	WEST	1.80

WARNING BEWARE OF UNDERGROUND SERVICES

The locations of underground services are approximate only and their exact position should be proven on site. No guarantee is given that all existing services are shown. Locate all underground services before commencement of works **DIAL 1100 BEFORE YOU DIG** www.1100.com.au

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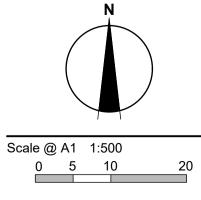
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eebo Properties Pty Ltd D Box 342 erwick, VIC, 3806



Date

October 2020



Levels: AHD

Coords: MGA

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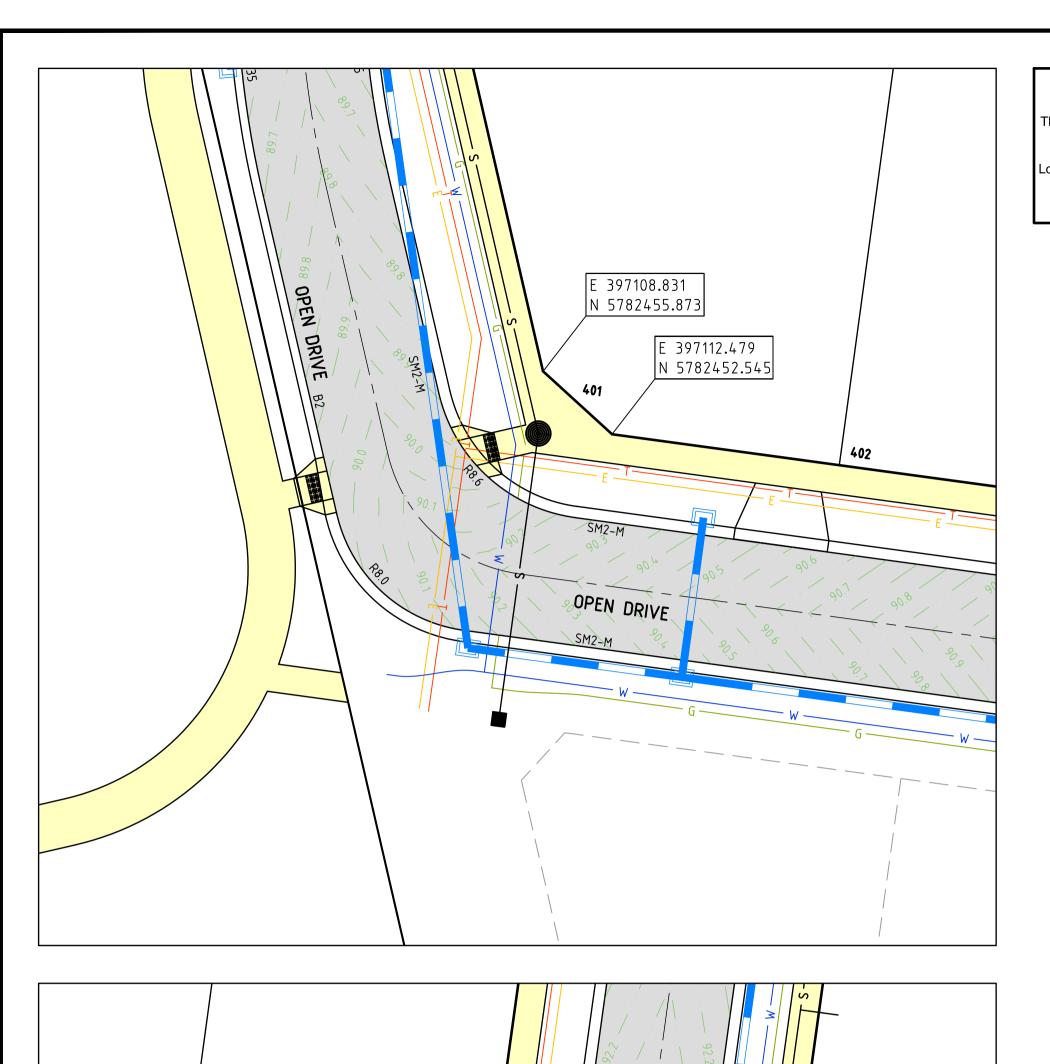
175 MCGLONE ROAD, DROUIN DETAILED DESIGN - STAGE 4

BAW BAW SHIRE COUNCIL - PLA0382/16 ROADWORKS AND DRAINAGE LAYOUT PLAN

Drawing No. 16028-04-02

Sheet No. 02 of 12

Rev 1




CART DRIVE


WARNING BEWARE OF UNDERGROUND SERVICES

The locations of underground services are approximate only and their exact position should be proven on site. No guarantee is given that all existing services are shown. Locate all underground services before commencement of works **DIAL 1100 BEFORE YOU DIG**


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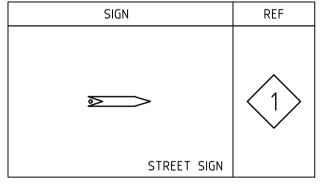
OPEN DRIVE (LOT 401)

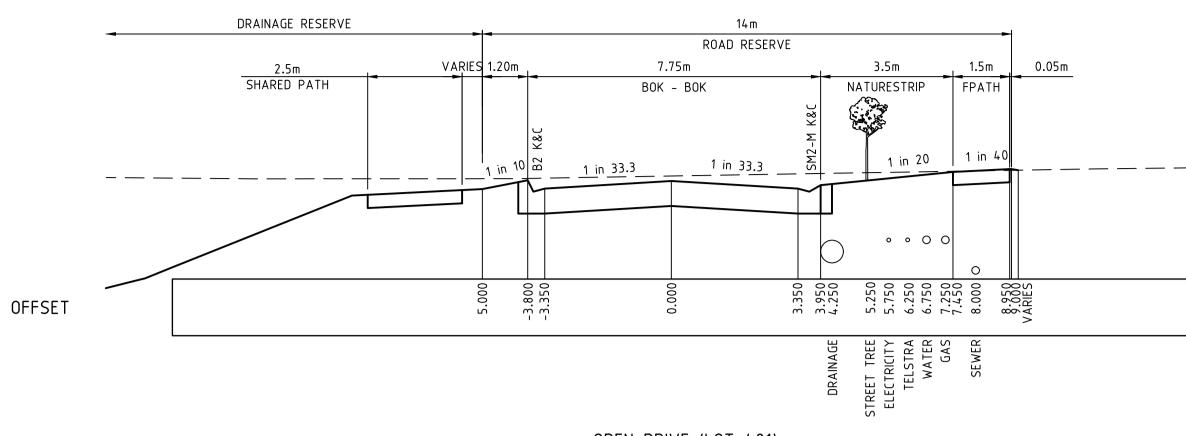


OPEN DRIVE (401-404)

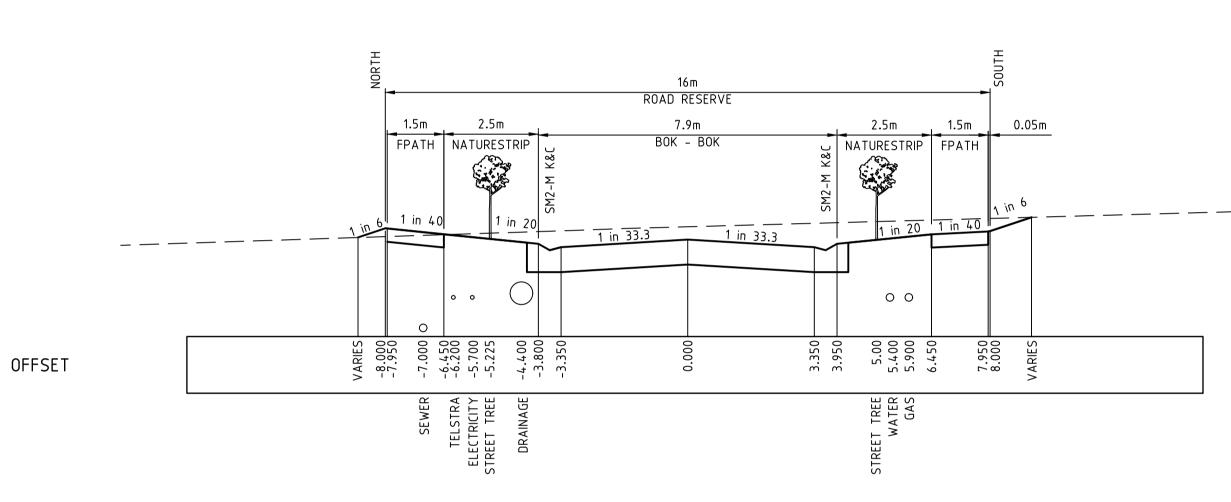



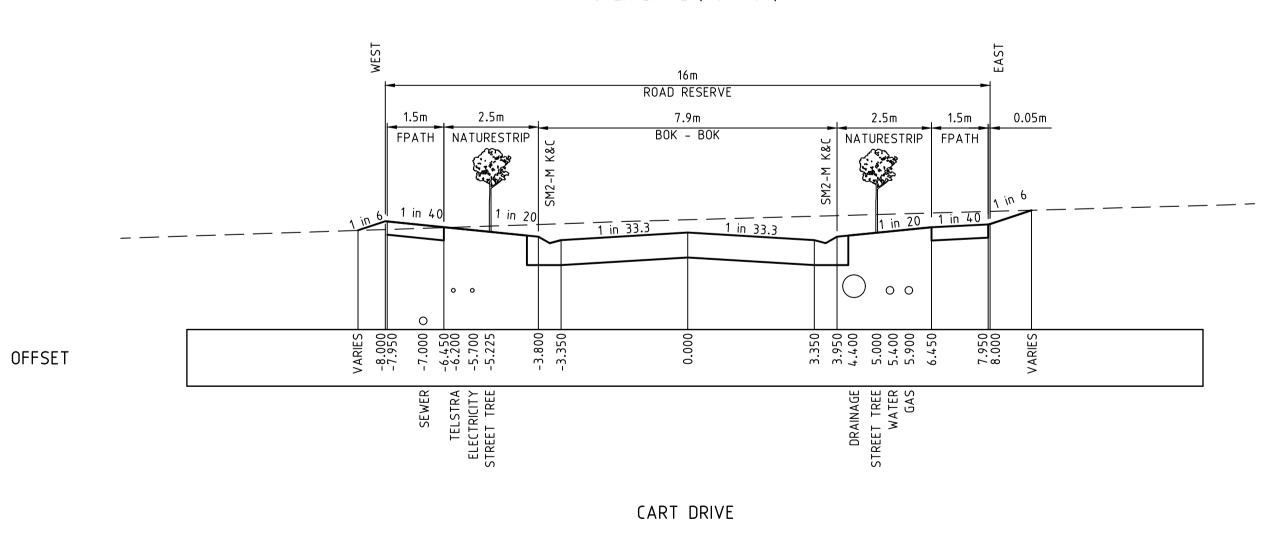

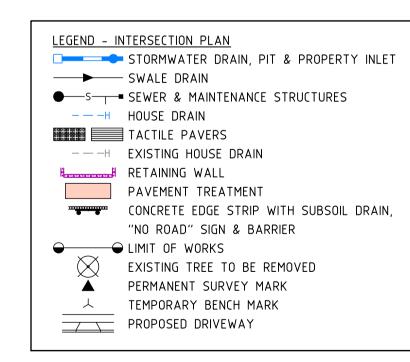

- 1. REFER TO SHEET No 16028-04-04 FOR SETOUT INFORMATION. 2. 90° BENDS TO HAVE CENTRELINE MARKING WITH RRPM'S AT
 - MAX 6m SPACING.

Designed

A.Cantwell

A.Cantwell

Checked

M.Warry

Authorised

October 2020

K.Taylor

Date

Drawn

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E 397172.467

OPEN DRIVE

E 397169.083

N 5782444.842

N 5782447.409


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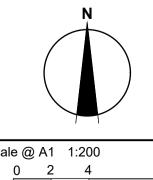
397188.321

N 5782445.251

E 397190.882 N 5782441.875



Coords: MGA

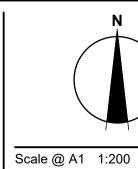

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175 MCGLONE ROAD, DROUIN

DETAILED DESIGN - STAGE 4 BAW BAW SHIRE COUNCIL - PLA0382/16 ROADWORKS AND DRAINAGE INTERSECTION DETAIL PLAN & TYPICAL CROSS SECTIONS

Drawing No. 16028-04-03 Sheet No. 03 of 12


Rev 1

LEGEND


— — EXISTING SURFACE

— DESIGN LINE

— FUTURE DESIGN LINE

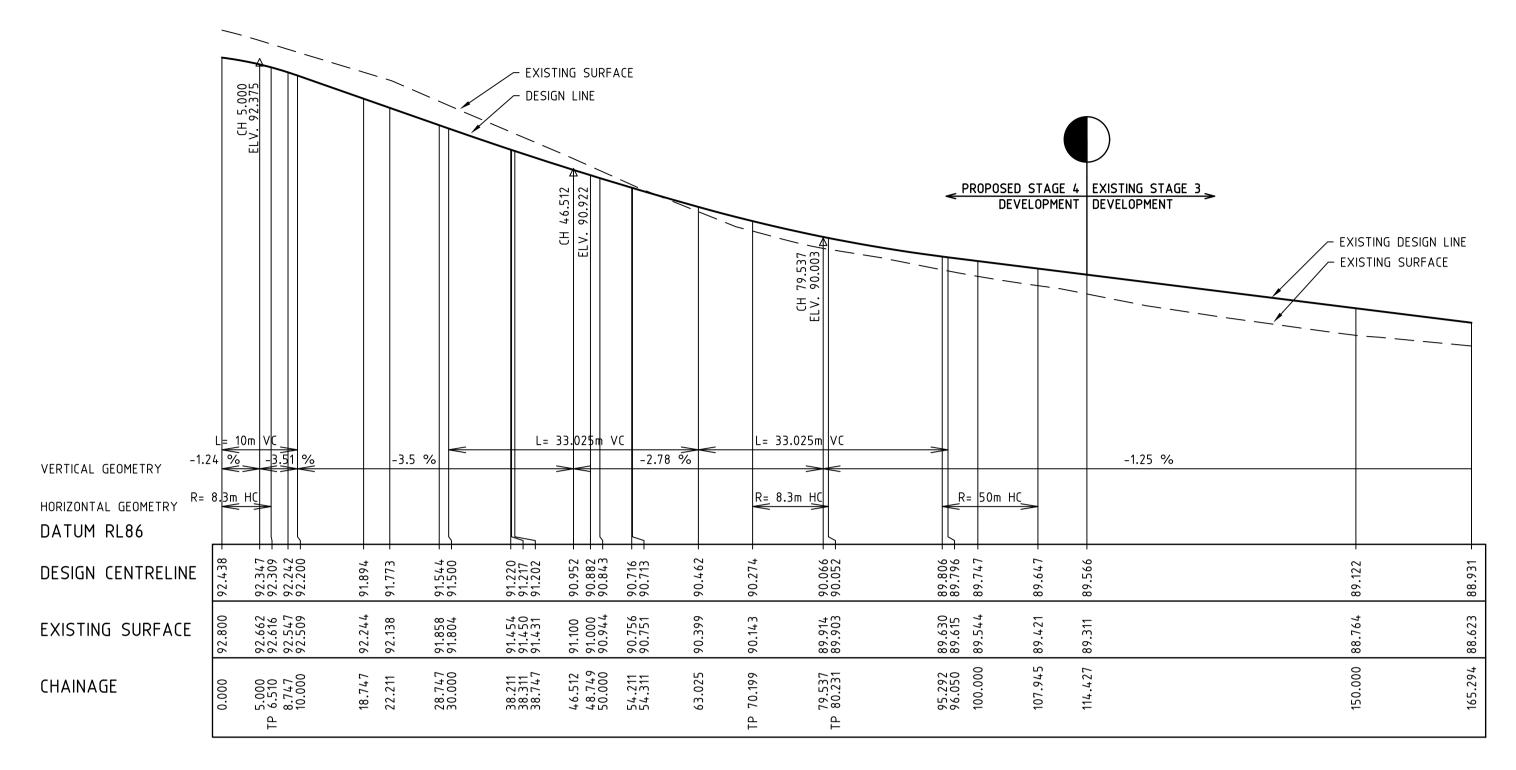

OPEN DRIVE LONGITUDINAL SECTION

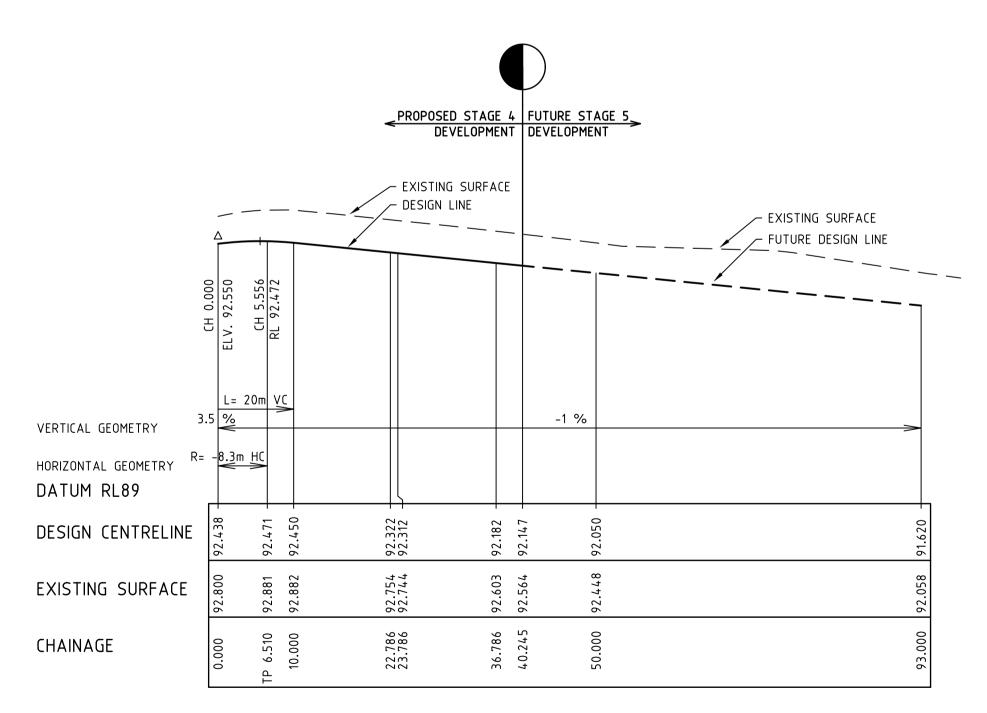

CART DRIVE LONGITUDINAL SECTION

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Principal Seebo Properties Pty Ltd PO Box 342 Berwick, VIC, 3806

Designed A.Cantwell Drawn A.Cantwell Checked M.Warry Authorised K.Taylor

Date

October 2020

Scale @	A1	H1:500	V1:50		
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0.000	371110.010	5/02450.105	232 40 40	
2.564	397174.569	5782436.951	250°30′41″	
5.128	397172.059	5782436.479	268°12′42″	
6.510		5782436.551	277°44′60″	C T
70.199		5782445.139	277°44′60″	T C
71.795	397106.022	5782445.505	288°46′03″	
74.359		5782446.689	306°28′04″	
76.923		5782448.505	324°10′05″	
79.487	397100.805	5782450.781	341°52′06″	
80.231	397100.605	5782451.496	347°00′00″	СТ
95.292	397097.217	5782451.470	347°00′00″	TC
			352°23′44″	1 C
100.000		5782470.802		
106.250	397095.937	5782477.033	359°33′27″	<i>c</i>
107.945		5782478.728	1°29′60″	CT
165.294	397097.454	5782536.057	1°29′60″	
CART DRIVE	DESIGN LINE			
CHAINAGE	EASTING	NORTHING	BEARING	
0.000	397176.816	5782438.163	5 2 ° 4 8 ′ 4 0 ′′	
2.564	397178.589	5782440.001	35°06′39″	
5.128	397179.719	5782442.292	17°24′38″	
6.510	397180.021	5782443.638	7°52′20″	CT
98.245	397192.586	5782534.509	7°52′20″	

NORTHING

0.000 397176.816 5782438.163 232°48′40″

BEARING

OPEN DRIVE DESIGN LINE


CHAINAGE EASTING


175 MCGLONE ROAD, DROUIN


DETAILED DESIGN - STAGE 4
BAW BAW SHIRE COUNCIL - PLA0382/16
ROADWORKS AND DRAINAGE
LONGITUDINAL SECTIONS & SETOUT INFORMATION

Drawing No. 16028-04-04 Sheet No. 04 of 12

Rev 1

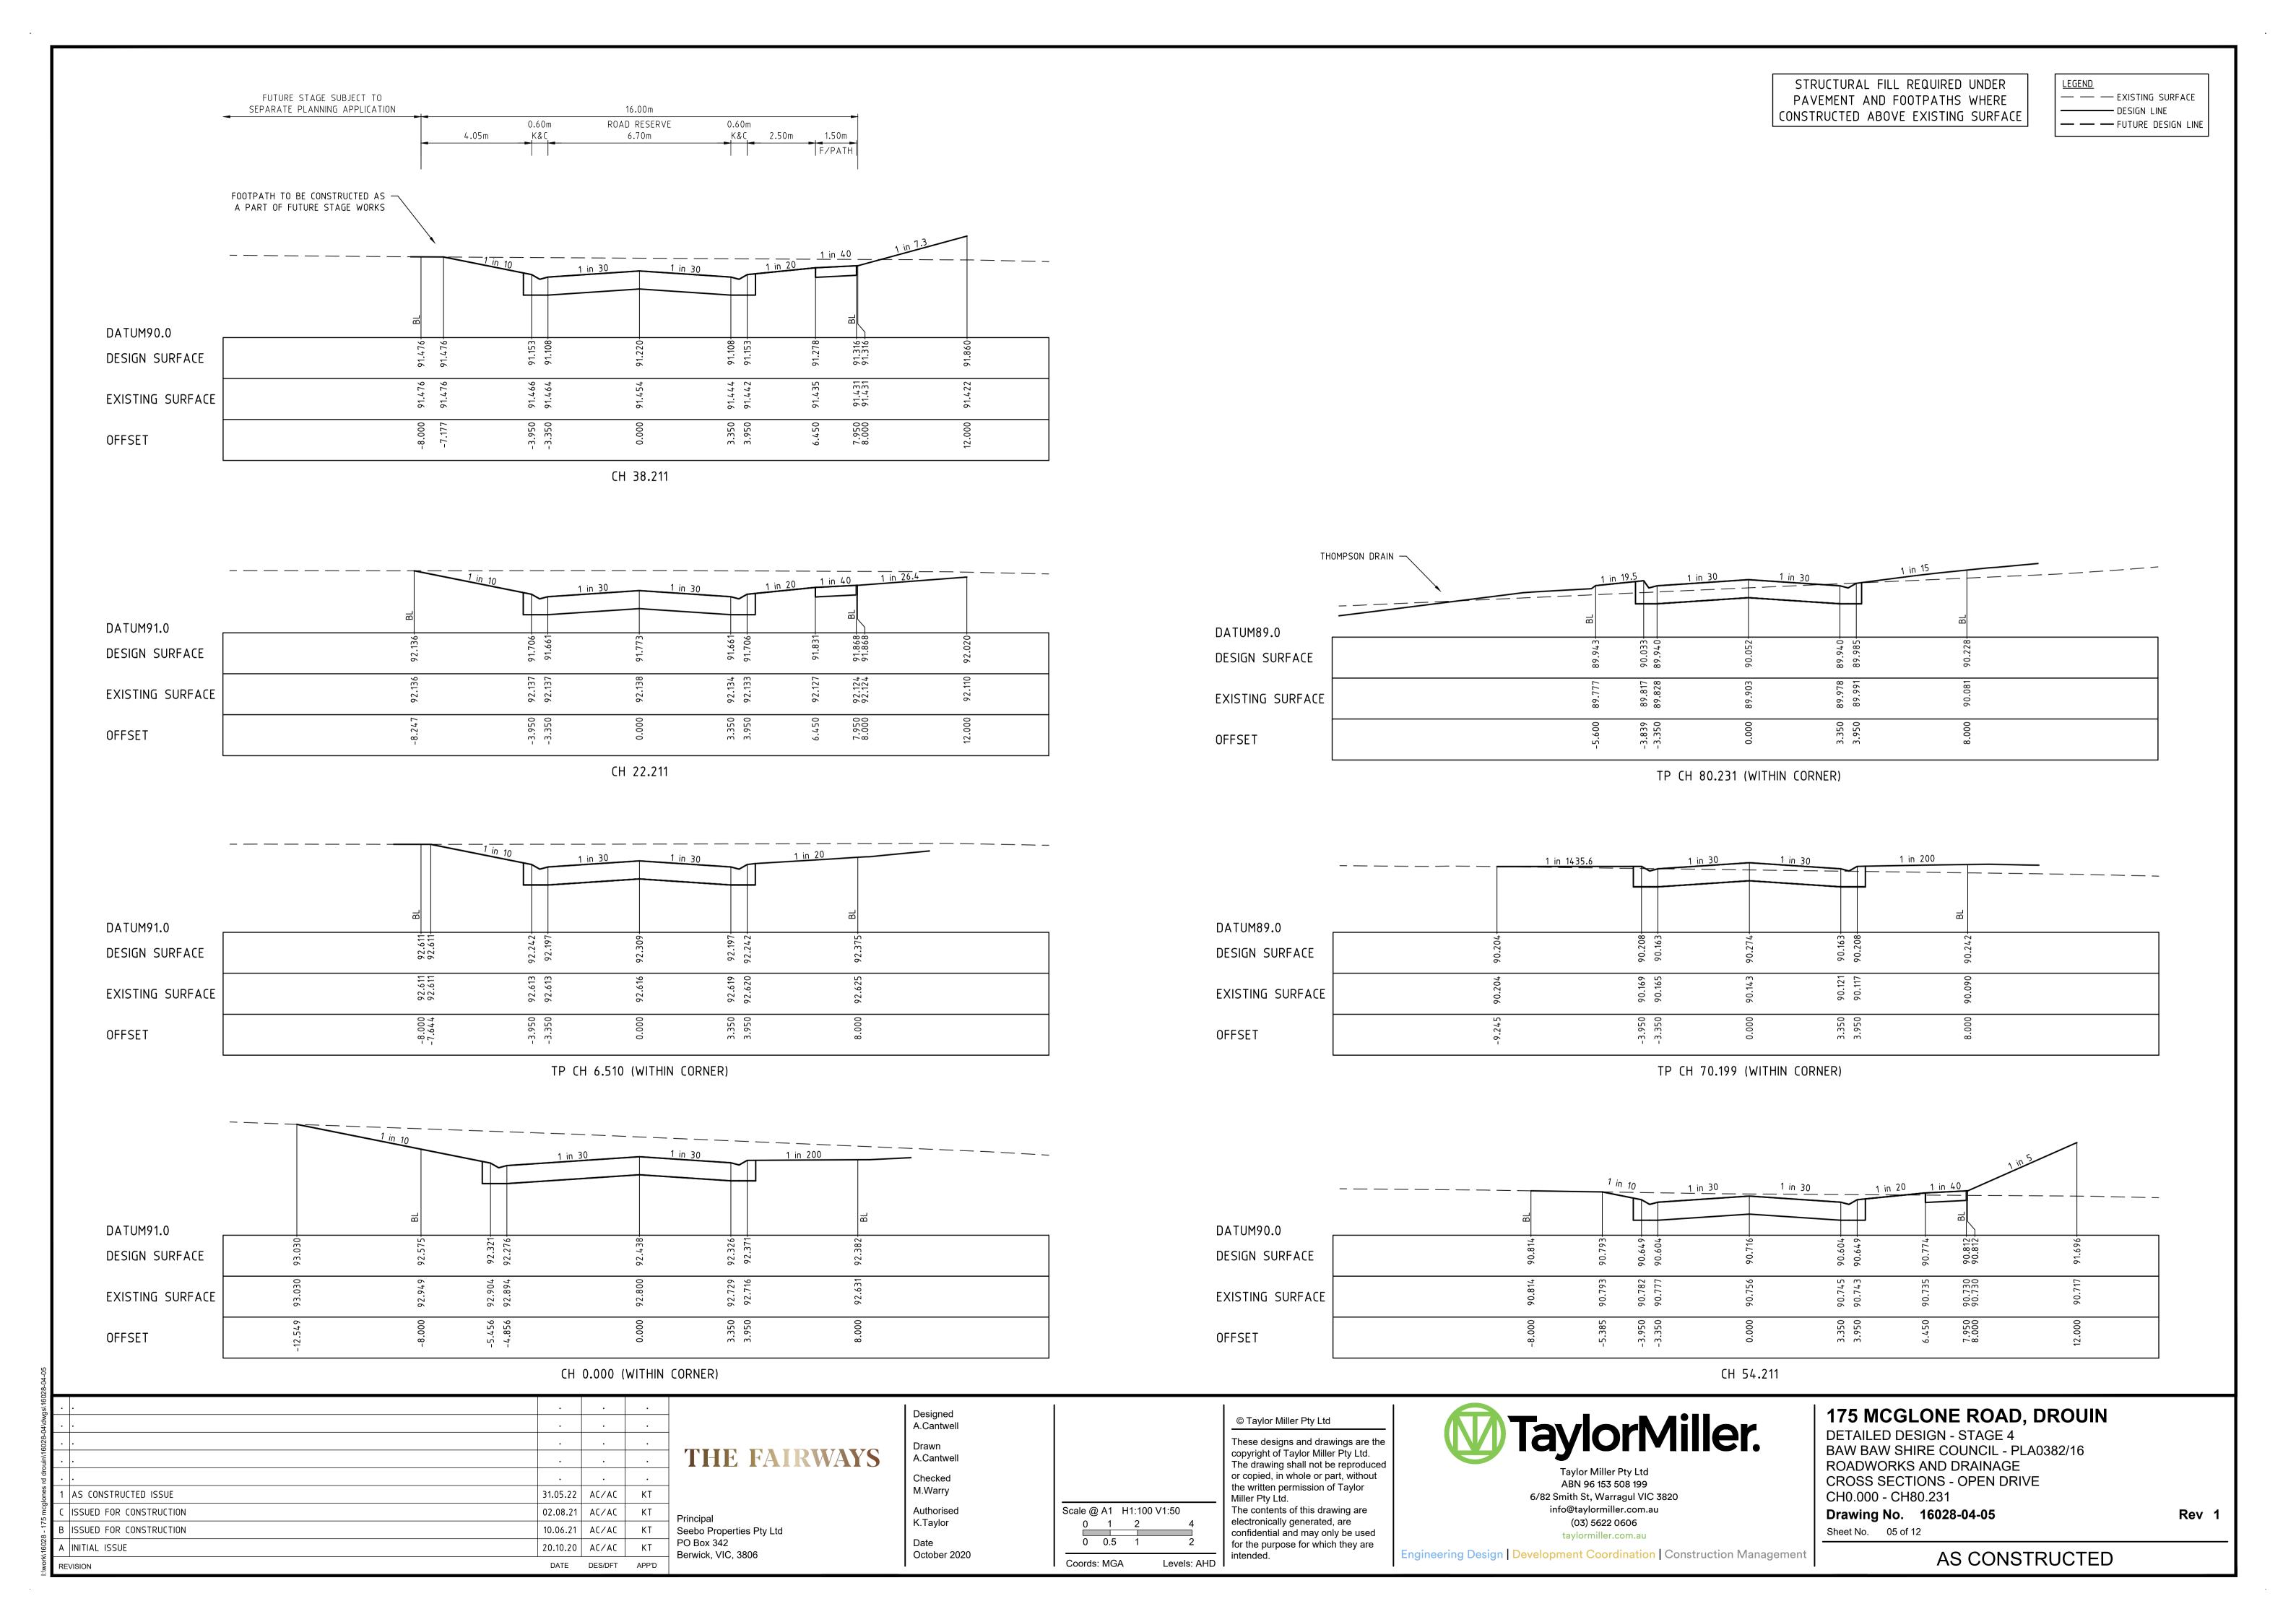

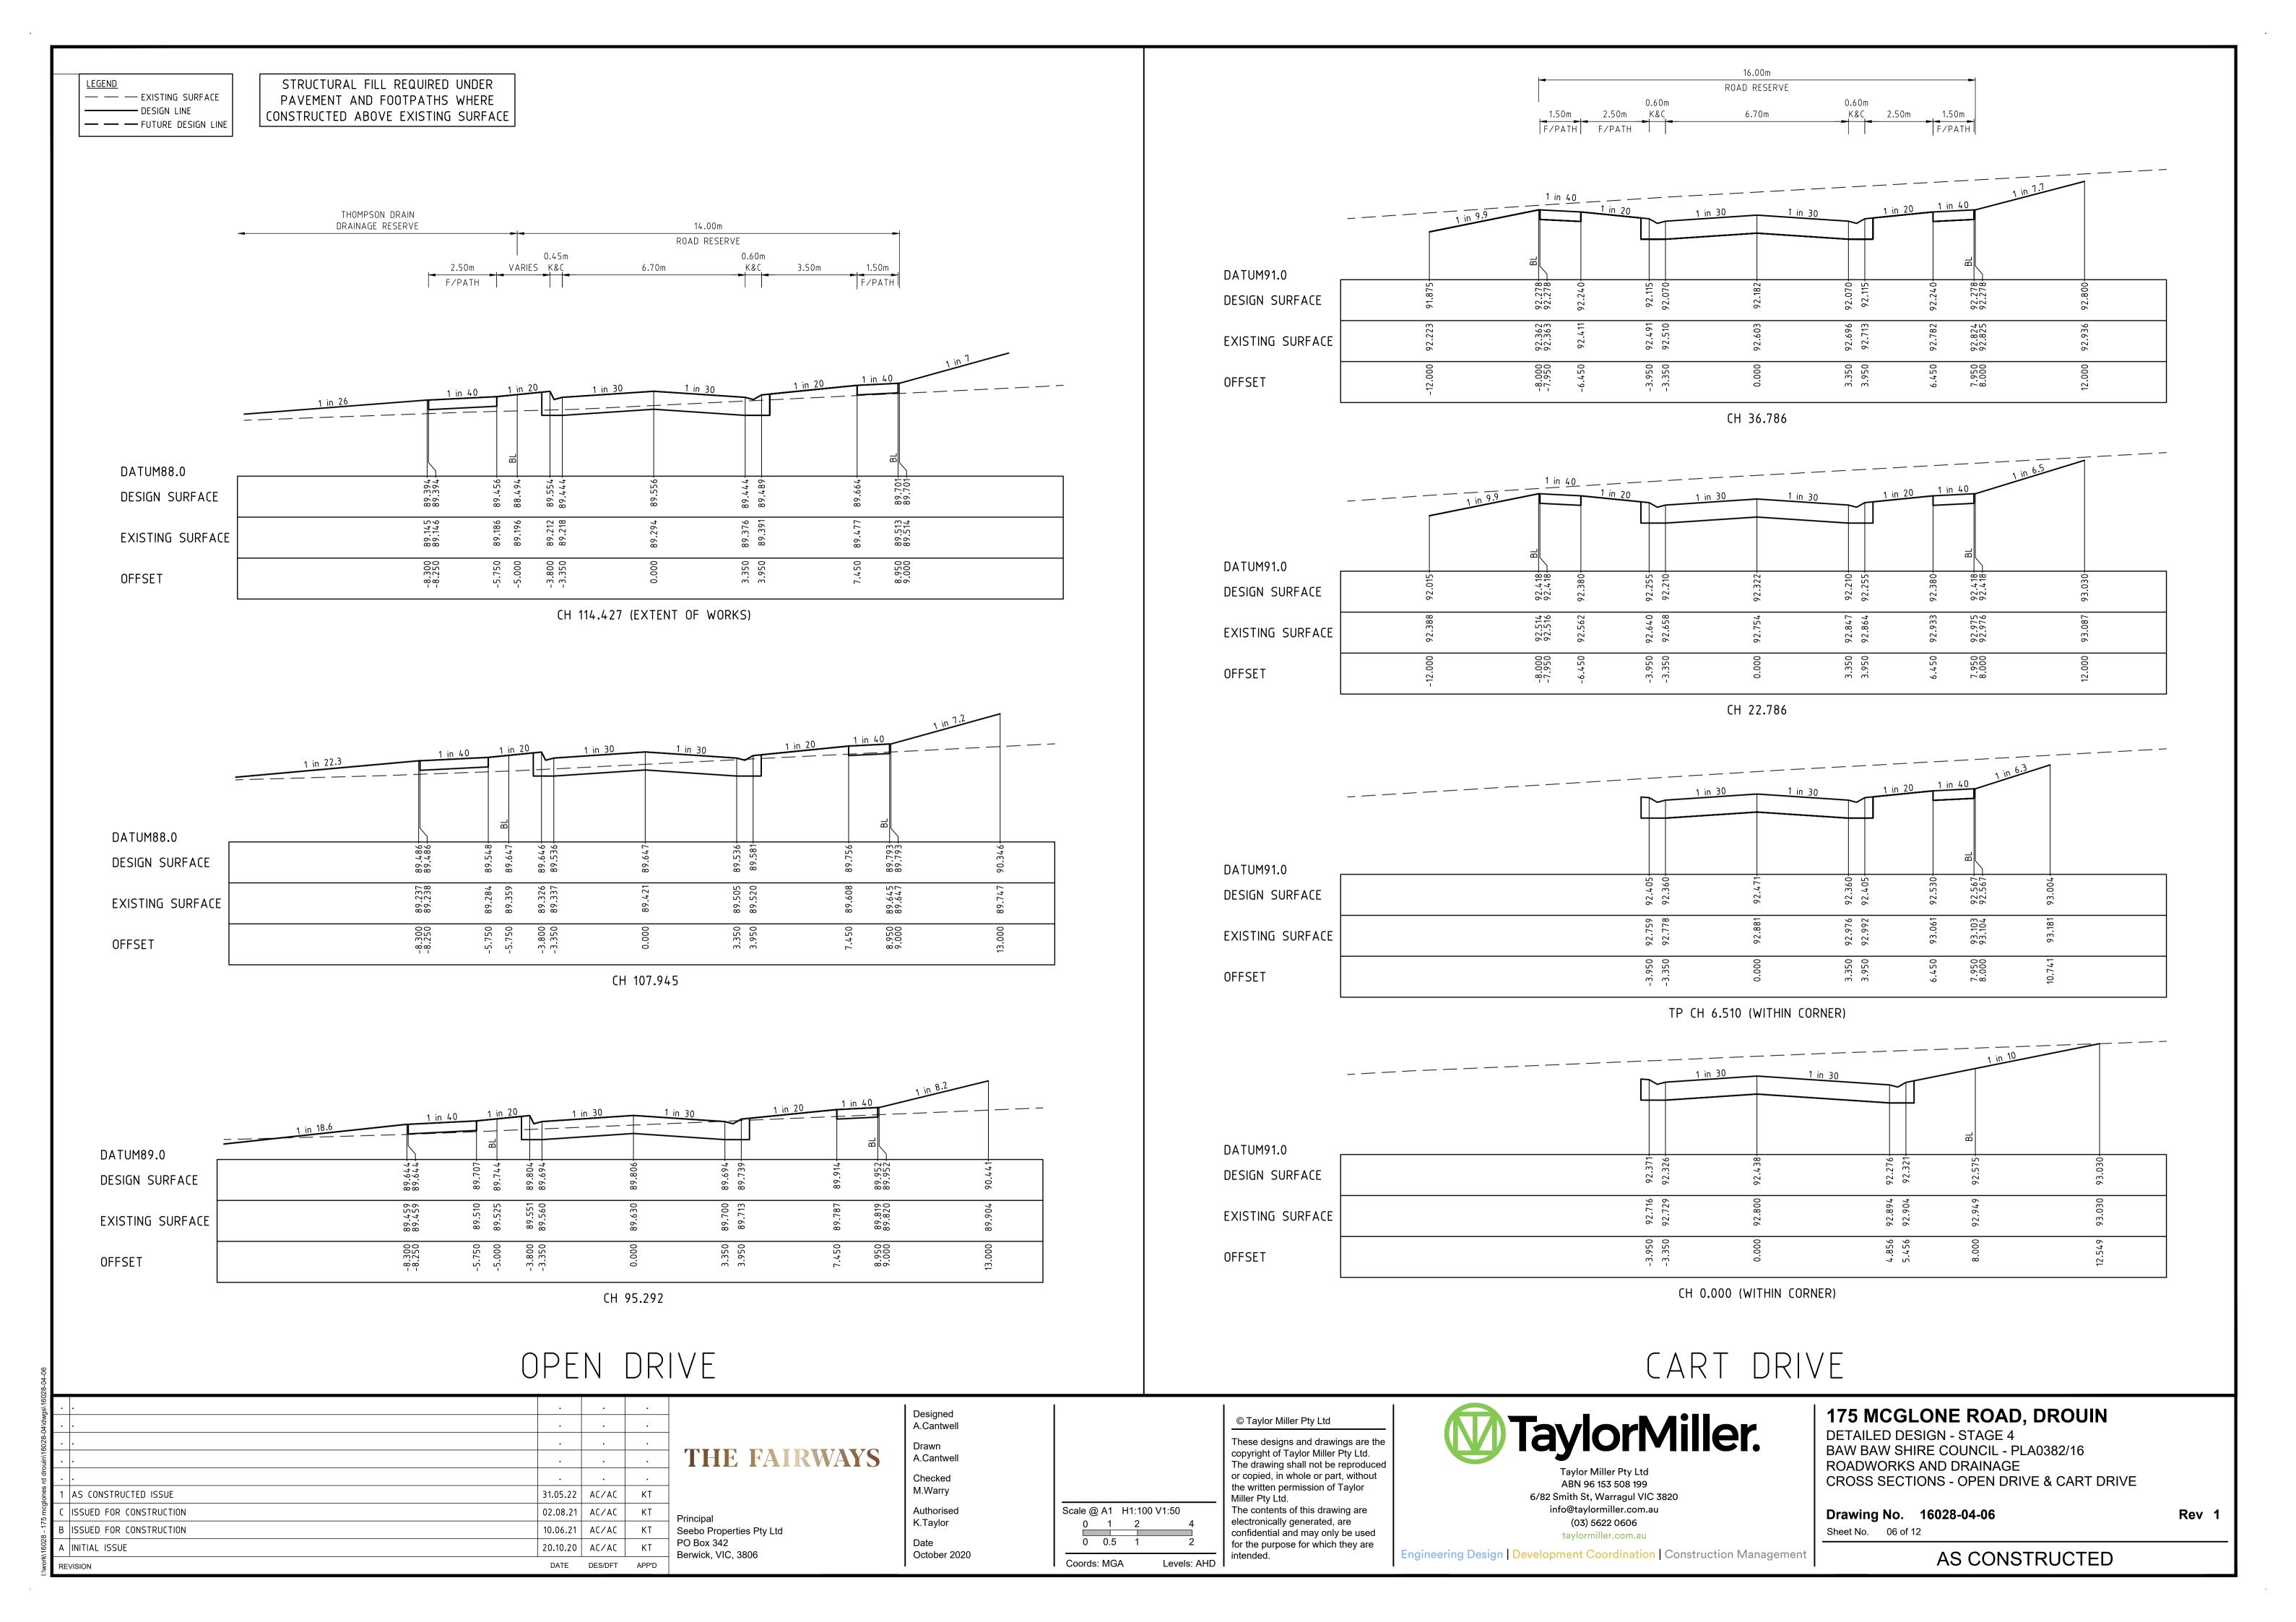

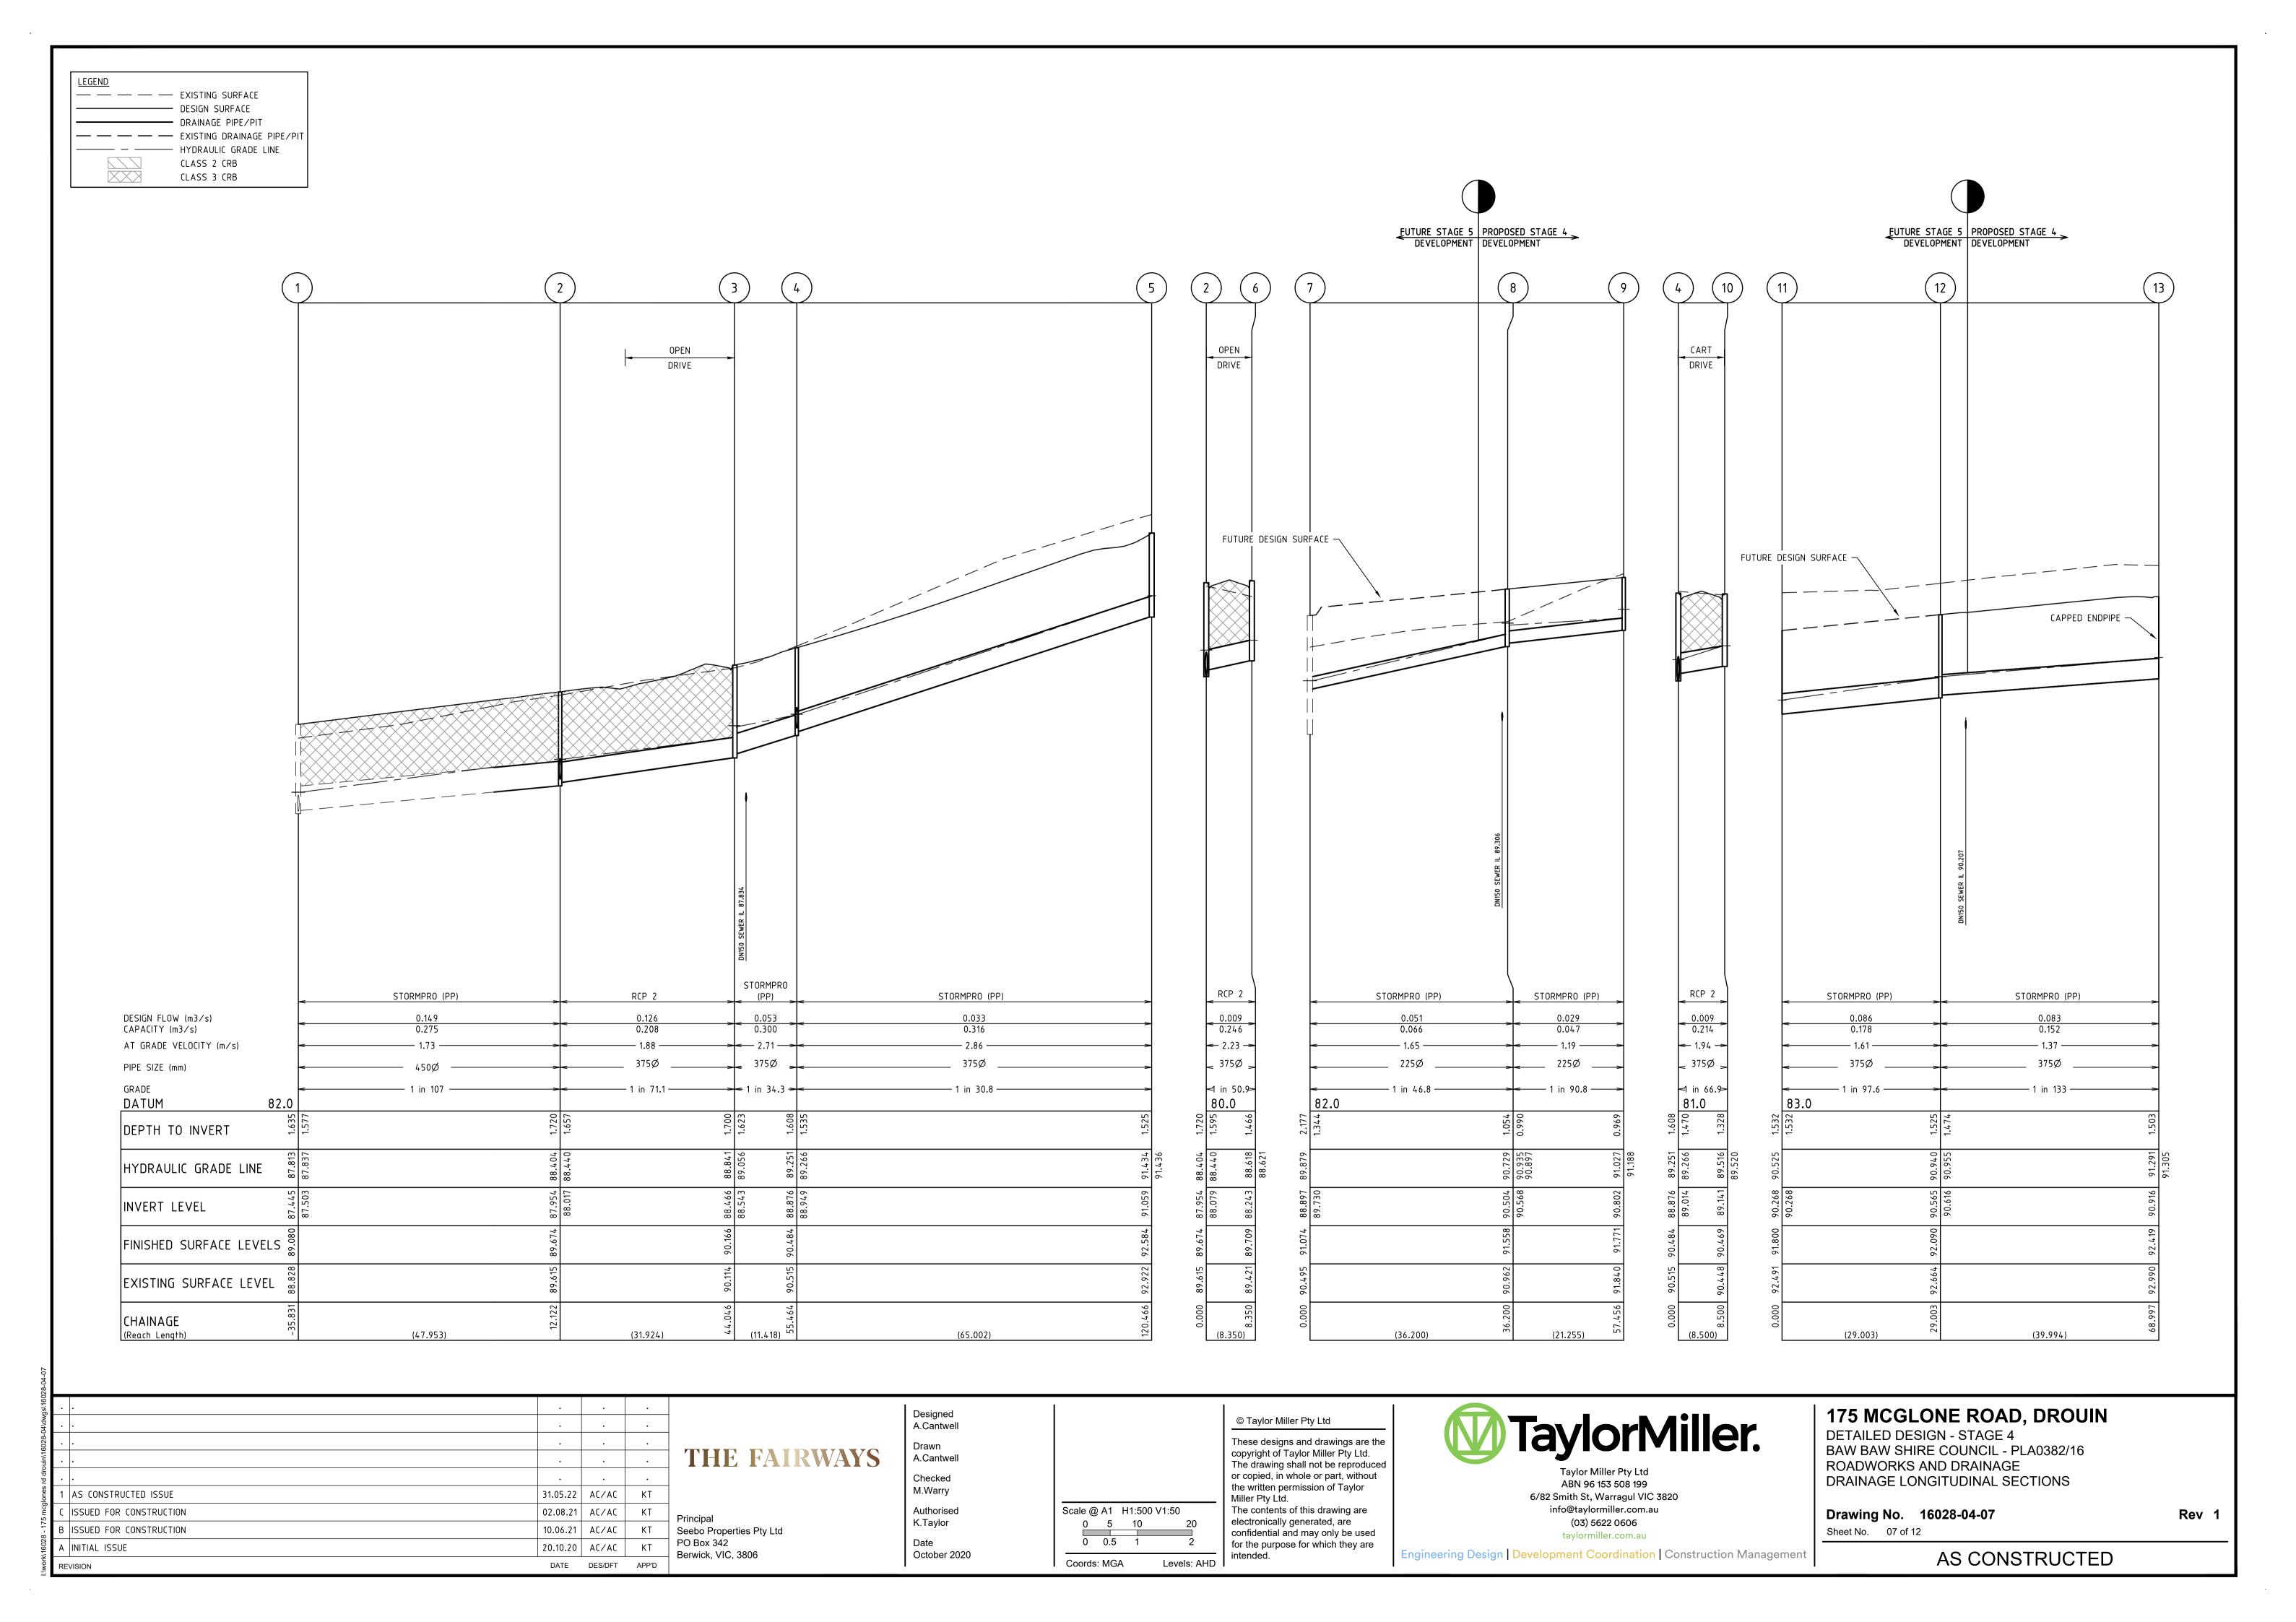

	PIT SCHEDULE													
	PIT	INTE	RNAL		INLET	C	OUTLET	COVER LEVEL (m)	DEPTH (m)	STANDARD DRAWING	REMARKS			
NAME	TYPE	WIDTH (mm)	LENGTH (mm)	DIA (mm)	INVERT RL (m)	DIA (mm)	INVERT RL (m)	COVER LEVEL (III)	DEPTH (III)	STANDARD DRAWING	REIVIANNS			
1	ENDPIPE			450	87.841			89.516	1.732		REMOVE EXISITNG TEMPORARY SANDBAG ENDWALL AND CONTINUE MAIN			
2	SIDE ENTRY PIT	900	600	375	88.017	450	87.954	89.674	1.720	IDM SD 435				
		SIDE ENTITY I			375	88.079					101VI 3D 433			
3	JUNCTION PIT	900	600	375	88.543	375	88.466	90.166	1.700	IDM SD 420				
1	SIDE ENTRY PIT	900	600	375	88.949	375	88.876	90.484	1.608	IDM SD 435				
4	SIDE ENTRY PIT			375	89.014					10W 3D 433				
5	JUNCTION PIT					375	91.059	92.584	1.525	IDM SD 420				
6	SIDE ENTRY PIT	900	600			375	88.243	89.709	1.466	IDM SD 430				
7	JUNCTION PIT			225	89.730			91.074	2.177	IDM SD 426	EXISTING JUNCTION PIT			
8	JUNCTION PIT	900	600	225	90.568	225	90.504	91.558	1.054	IDM SD 426				
9	JUNCTION PIT	900	600			225	90.802	91.771	0.969	IDM SD 426				
10	SIDE ENTRY PIT	900	600			375	89.141	90.469	1.328	IDM SD 435				
11	ENDWALL			375	90.268			91.800	1.532		TEMPORARY SANDBAG ENDWALL			
12	JUNCTION PIT	900	600	375	90.616	375	90.565	92.090	1.525	IDM SD 420	PROVIDE BLOCKOUT IN WEST WALL FOR FUTURE DN375 DRAIN @ IL90.648			
13	ENDPIPE					375	90.916	92.419	1.503		CAP 375mm Dia. PIPE			

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Designed A.Cantwell Drawn A.Cantwell Checked M.Warry Authorised K.Taylor Date

October 2020

Scale @ A1 H1:500 V1:50 0 5 10 0 0.5 1

Coords: MGA

intended.

Levels: AHD

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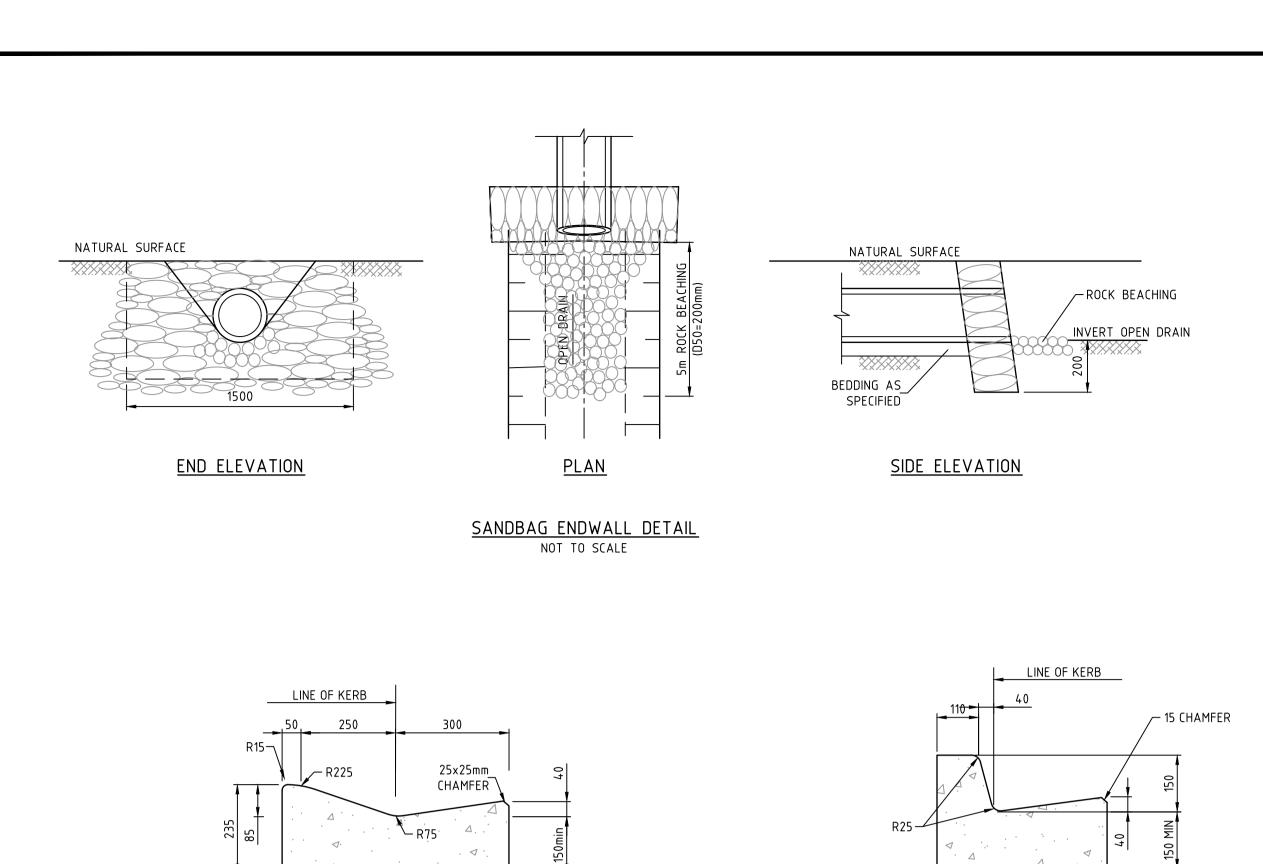
175 MCGLONE ROAD, DROUIN
DETAILED DESIGN - STAGE 4 BAW BAW SHIRE COUNCIL - PLA0382/16 ROADWORKS AND DRAINAGE
PIT SCHEDULE

Drawing No. 16028-04-08

Sheet No. 08 of 12

AS CONSTRUCTED

Rev 1



NO PERMANENT LOADS WITHIN THIS AREA

PROVIDE APPROVED MOISTURE

BARRIER TO REAR OF WALL.

APPROVED GRAVEL, OR

90Ø AGRICULTURAL DRAIN


EXTEND TO STORMWATER.

-FOR RETAINING WALL GREATER THAN

DATE DES/DFT APP'D


1.0m REFER TO STRUCTURAL ENGINEERING DESIGN AND BUILDING PERMIT (BY OTHERS)

RUBBLE BACKFILL.

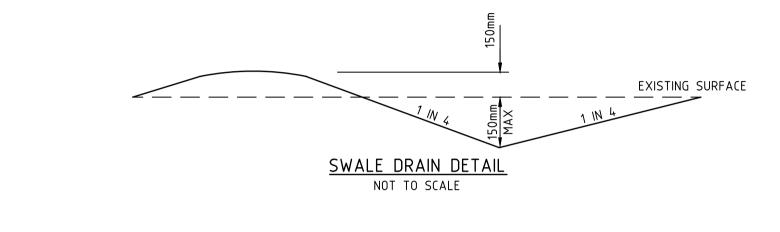

PAVEMENT DETAIL

ALL ROADS

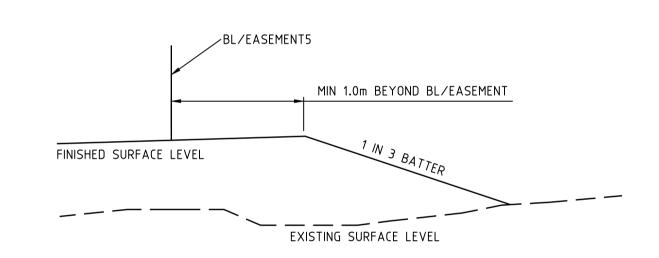

30mm DEPTH COMPACTED 10mm NOM.

100mm DEPTH COMPACTED 20mm CLASS 2 CRUSHED ROCK.

- 200mm DEPTH COMPACTED 20mm CLASS 3 CRUSHED ROCK.

SUBGRADE IMPROVEMENT (TYPICALLY 200mm 3% LIME 3%

COMPACT TO 98% MODIFIED COMPACTION IN 2 LAYERS.


SUBGRADE TREATMENT (ONLY WHERE C.B.R <5%)

CEMENT) AS DIRECTED BY SUPERINTENDENT

COMPACT TO 98% MODIFIED COMPACTION IN 1 LAYER.

ASPHALT TYPE N

TYPICAL FILL BATTER DETAIL NOT TO SCALE

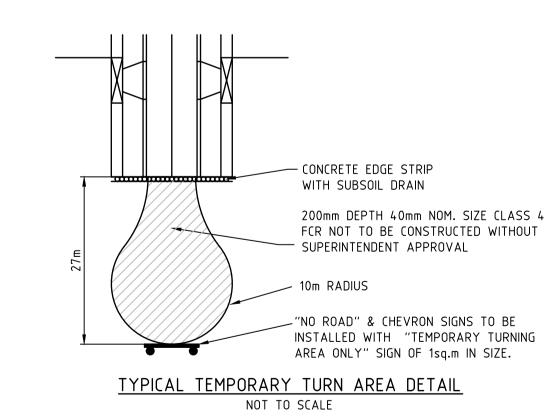

GENERAL NOTES

- 1. THE WORKS SHALL BE CONSTRUCTED IN ACCORDANCE WITH THE CURRENT COUNCIL STANDARD DRAWINGS AND SPECIFICATIONS. WORKS TO BE CARRIED OUT TO THE SATISFACTION OF COUNCIL'S SUPERVISING OFFICER.
- 2. THE CONTRACTOR IS RESPONSIBLE FOR SAFETY OF WORK ON SITE IN ACCORDANCE WITH APPROPRIATE LEGISLATION. THEY SHALL ERECT AND MAINTAIN ALL SHORING, PLANKING AND STRUTTING, DEWATERING DEVICES, BARRICADES, SIGNS, LIGHTS, ETC. NECESSARY TO KEEP WORKS IN A SAFE AND STABLE CONDITION, AND TO PROTECT THE PUBLIC FROM HAZARDS ASSOCIATED WITH THE WORKS.
- 3. THE CONTRACTOR SHALL: A. COMPLY WITH THE SAFETY REQUIREMENTS OF THE MINES ACT, GENERAL REGULATIONS AND STATUTORY RULES, AND
 - THE MINES (TRENCHES) REGULATIONS 1982. B. NOTIFY THE OCCUPATIONAL HEALTH AND SAFETY AUTHORITY OF HIS INTENTION TO COMMENCE TRENCHING OPERATIONS
 - WHERE TRENCHES ARE 1.5 METRES OR DEEPER.
- ENSURE THAT THE MINE MANAGER OR HIS DEPUTY AS REQUIRED BY THE REGULATIONS IS IN ATTENDANCE WHEN TRENCHING OPERATIONS ARE IN PROGRESS.
- 4. THE CONTRACTOR IS TO NOTIFY COUNCIL AND ALL SERVICE AUTHORITIES SEVEN (7) DAYS PRIOR TO COMMENCEMENT OF CONSTRUCTION.
- 5. THE LOCATION OF EXISTING SERVICES SHOULD BE DETERMINED BY THE CONTRACTOR PRIOR TO COMMENCING ANY
- EXCAVATION BY CONTACTING ALL RELEVENT SERVICE AUTHORITIES. ANY EXISTING SERVICES SHOWN ON THE DRAWINGS ARE OFFERED AS A GUIDE ONLY AND ARE NOT GUARANTEED AS CORRECT.
- 6. TREES MARKED ON THE APPROVED PLANS FOR REMOVAL MUST BE REMOVED FROM THE SITE PRIOR TO THE COMMENCEMENT OF WORKS. NO EXCAVATION SHALL BE CARRIED OUT WITHIN 5.0m OF ANY EXISTING TREE UNTIL APPROVAL HAS BEEN GIVEN BY COUNCIL'S SUPERVISING OFFICER. THE REMOVAL OR RETENTION OF EXISTING TREES MUST BE IN ACCORDANCE WITH THE APPROVED LANDSCAPE PLANS. OTHERWISE, APPROVAL WILL BE REQUIRED FROM THE LANDSCAPE APPROVAL
- 7. ALL ROAD CHAINAGES ARE MEASURED ALONG THE ROAD CENTRELINE EXCEPT KERB RETURNS AND COURTHEADS, WHERE LIP OF KERB CHAINAGES ARE SPECIFIED. ALL DIMENSIONS AND RADII ARE GIVEN TO THE LIP OF KERB. DO NOT SCALE OFF THESE DRAWINGS, WRITTEN DIMENSIONS ONLY SHALL BE USED.
- 8. CONDUIT LOCATIONS ARE SUBJECT TO AMENDMENT AND CONDUITS SHALL NOT BE LAID UNTIL WRITTEN APPROVAL IS GIVEN BY THE SUPERINTENDENT AND/OR COUNCIL'S SUPERVISING OFFICER. CONDUITS TO BE PLACED A MINIMUM OF 1.4m FROM BOUNDARIES/EASEMENTS AND TO THE SATISFACTION OF THE SUPERINTENDENT AND/OR COUNCIL'S SUPERVISING OFFICER. BOTH KERBS ARE TO BE MARKED WITH THE LETTERS G,W,E AND T ABOVE CONDUIT LOCATIONS AS SPECIFIED. TELSTRA CONDUITS WILL BE SUPPLIED BY TELSTRA AT TELSTRA'S EXPENSE, IN TRENCHES EXCAVATED AND BACKFILLED BY THE CONTRACTOR. TELSTRA SIZE VARIES - WHITE P.V.C.. TELSTRA TO BE NOTIFIED 7 DAYS PRIOR TO PLACEMENT OF CONCRETE WORKS. GAS AND WATER CONDUITS TO BE 50mm DIA. HEAVY DUTY P.V.C. LAID AT A MINIMUM DEPTH OF 600mm BELOW ROAD FINISHED SURFACE LEVELS.
- 9. SUBSOIL DRAINS SHALL BE INSTALLED BEHIND ALL KERB AND CHANNEL AS PER COUNCIL SPECIFICATION AND STANDARD
- 10. ALL LINEMARKING, SIGNING & TRAFFIC CONTROL DEVICES FOR THIS PROJECT TO BE IN ACCORDANCE WITH AUSTRALIAN
- STANDARD AS1742. ALL LINEMARKING TO BE LONG LIFE THERMOPLASTIC PAINT.
- 11. ALL LEVELS ARE TO AUSTRALIAN HEIGHT DATUM. 12. THE CONTRACTOR SHALL CO-OPERATE WITH OTHER AUTHORITIES AND SHALL ENSURE THAT ALL SERVICES ARE INSTALLED PRIOR TO THE FINAL PAVEMENT COURSE. THE CONTRACTOR SHALL CHECK WITH THE SUPERINTENDENT AND/OR COUNCIL'S SUPERVISING OFFICER THE EXACT LOCATION OF ALL SERVICES PRIOR TO THE INSTALLATION OF CONDUITS.
- 13. ANY EXISTING PAVEMENT OR DRAINAGE WORKS DAMAGED DURING CONSTRUCTION OR THE MAINTENANCE PERIOD TO BE REINSTATED TO THE SATISFACTION OF THE COUNCIL REPRESENTATIVE.
- 14. FILLING IN PROPERTIES AND ROAD RESERVE IS TO BE CARRIED OUT USING APPROVED CLAY FILL. TOPSOIL AND ALL VEGETABLE MATTER TO BE STRIPPED FROM FILL SITE PRIOR TO FILLING. ALL FILLING TO BE CARRIED OUT IN 150mm LAYERS AND COMPACTED TO 95% OF MAX. DRY DENSITY UNDER THE STANDARD AASHO TEST. ALL FILLING TO COMPLY WITH AS 3798/1996, APPENDIX B , LEVEL 1. IF ANY EXISITNG SUBSTANDARD FILLING IS ENCOUNTERED ON THE SITE, IT MUST BE REMOVED AND REPLACED WITH APPROVED FILL MATERIAL COMPACTED TO COUNCIL REQUIREMENTS. A GEOTECHNICAL REPORT MUST BE SUBMITTED SHOWING DETAILS OF DEPTH, TYPE OF MATERIAL AND DENSITY OF THE FILL AREAS
- 15. THE NATURE STRIPS AND CUT OR FILLED AREAS ARE TO BE TOPSOILED WITH 100mm OF APPROVED MATERIAL. IF THE
- LOCAL SOIL IS NOT SUITABLE, APPROVED SOIL SHALL BE IMPORTED AT THE CONTRACTOR'S EXPENSE. 16. UNLESS OTHERWISE SHOWN, BATTERS INTO ALLOTMENTS SHALL NOT BE STEEPER THAN 1 IN 3 CUT AND 1 IN 6 FILL. CUT
- BATTERS ARE TO BE GRASSED AND MULCHED WITH A MIXTURE OF CHOPPED GRASS, STRAW AND BITUMEN EMULTION 17. LOTS SHALL BE GRADED TO ENSURE A MINIMUM GRADE OF 1 IN 150 ON THE LOWEST SIDE BOUNDARY TO THE POINT OF
- DRAINAGE.
- 18. ALL 150Ø PIPE TO BE PVC (Sn10), 225Ø TO 900Ø INCLUSIVE TO BE RRJ R.C. ALL R.C PIPES TO BE CLASS 2 UNLESS
- 19. STORMWATER DRAINS UNDER PAVEMENTS ARE TO BE BACKFILLED WITH CLASS 2 CRUSHED ROCK.
- 20. STORMWATER DRAINS UNDER FOOTPATHS, DRIVEWAYS AND BEHIND KERB WHERE SIDE OF TRENCH COMES WITHIN 150mm OF THE BACK OF KERB TO BE BACKFILLED WITH CLASS 3 CRUSHED ROCK, UNLESS SHOWN OTHERWISE 21. ALL HOUSE DRAINS ARE TO BE CONNECTED DIRECT TO AN UNDERGROUND DRAIN OR PIT. CONNECT HOUSE DRAIN AS PER
- INFRASTRUCTURE DESIGN MANUAL STANDARD DRAWING SD 515 & SD 520. OFFSET 1m FROM LOW SIDE BOUNDARY UNLESS OTHERWISE INDICATED.
- 22. PROPERTY INLET PITS ARE TO BE LOCATED 1.00m FROM LOW SIDE BOUNDARY UNLESS OTHERWISE SHOWN. INVERT LEVEL OF PROPERTY INLET IS TO BE A MINIMUM OF 400mm BELOW FINISHED/EXISTING SURFACE LEVEL. A PROPERTY INLET GULLY BASIN IS NOT REQUIRED AT PROPERTY INLET POINTS. 23. DRIVEWAYS ARE PROVISIONAL ITEMS AND SHOWN ON PLAN ONLY TO INDICATE PREFERED LOCATIONS. DRIVEWAYS TO BE
- CONSTRUCTED IN ACCORDANCE WITH THE INFRASTRUCTURE DESIGN MANUAL STANDARD DRAWINGS SD 240 & SD 245. DRIVEWAYS TO BE LOCATED 0.60m FROM BUILDING LINE AND CLEAR OF DRAINAGE PITS, SEWER MAINTENANCE HOLES AND EXISTING TREES. DOUBLE DRIVEWAY WIDTH TO BE 7.2m AT FRONT OF PATH/BUILDING LINE
- 24. ALL FOOTPATHS, SHARED PATHS AND OR BICYCLE PATHS ARE TO BE 125mm THICK 25Mpa SL72 MESH REINFORCEMENT PLACED CENTRALLY WITH 50mm BEDDING AS PER INFRASTRUCTURE DESIGN MANUAL STANDARD DRAWINGS SD 205 & SD
- 25. ALL STREET SIGNS ARE TO BE TO CURRENT BAW BAW SHIRE COUNCIL PLA0382/16 STANDARD, INCLUDING PROVISION OF
- 26. SIGNS, PAVEMENT MARKINGS AND DELINEATORS ARE TO BE INSTALLED AS APPLICABLE IN ACCORDANCE WITH AS1742.2. ALL PAVEMENT MARKINGS TO BE LONG LIFE ROAD MARKING WITH LONGITUDINAL LINES IN THERMOPLASTIC AND TRANSVERSE
- MARKINGS IN COLD APPLIED. 27. NO SURPLUS TREES, VEGETATION OR OTHER MATERIALS IS TO BE BURNT ON SITE
- 28. ANY SOFT ROCK USED IS TO CONFORM TO THE BAW BAW SHIRE COUNCIL PLA0382/16 SPECIFICATION FOR RIPPED ROCK. 29. APPROPRIATE SILTATION CONTROL IS TO BE CARRIED OUT DURING THE CONSTRUCTION AND MAINTENANCE PERIODS.
- 30. CONCRETE TO BE PLACED AROUND ELECTRICAL DISTRIBUTION PITS TO A MINIMUM DEPTH OF 200mm. DISTRIBUTION PITS TO BE A MINIMUM OF 300mm FROM EDGE OF FOOTPATHS.
- 31. UPON COMPLETION OF CONSTRUCTION, THE WHOLE SITE SHALL BE CLEANED UP AND GRADED OVER. ALL RUBBISH IS TO BE REMOVED AND THE SITE IS TO BE LEFT IN A CLEAN AND TIDY CONDITION TO THE SATISFACTION OF THE SUPERINTENDENT
- AND/OR COUNCIL'S SUPERVISING OFFICER. 32. ALL KERB AND CHANNEL THROUGHOUT THE ESTATE IS TO BE AS PER THE DESIGN PLANS. INTERSECTION KERB AND
- CHANNEL IS TO BE SEMI-MOUNTABLE (SM2). INFRASTRUCTURE DESIGN MANUAL STANDARD DRAWING SD 100.
- 33. TACTILE PAVERS ARE PROVISIONAL ITEMS AND POSSIBLE LOCATIONS SHOWN. CONTRACTOR TO WHEREVER POSSIBLE MEET PRAM CROSSING GRADES WHICH NEGATES THE NEED FOR TACTILES IF INSTALLED, TACTILED PAVERS AND GRADES ARE BE IN ACCORDANCE WITH AUSTRALIAN STANDARD AS1428.4.
- 34. EXISTING OPEN DRAIN TO BE EXCAVATED TO REMOVE ALL SOFT MATERIAL TO A WIDTH OF A MINIMUM 1m WIDER THAN THE DRAIN AND A MINIMUM DEPTH OF 300MM. THE EXCAVATED AREA SHALL BE INSPECTED AT THIS POINT TO DETERMINE WHETHER FURTHER EXCAVATION IS NECESSARY.

ORIGIN ENERGY - STANDARD NOTES

- GAS MAINS, FITTINGS AND MARKER TAPE ARE TO BE SUPPLIED BY ORIGIN ENERGY.
- EXCAVATION, SUPPLY AND PLACEMENT OF REQUIRED BACKFILL TO BE BY OTHERS.
- 3. TWO WEEKS OF NOTIFICATION OF COMMENCEMENT OF EXCAVATION WORKS SHALL BE GIVEN TO THE RELEVANT AUTHORITY.

REINFORCED CONCRETE PIPE

- ALL STORMWATER DRAINAGE PIPES SHALL NOT BE SUBJECTED TO CONSTRUCTION TRAFFIC LOADING DURING CONSTRUCTION
- COMPUTATIONS ARE TO ACCORD WITH AS.3725-1989, LOADS ON BURIED PIPES. CONCRETE PIPES DAMAGED DUE TO CONSTRUCTION LOADS SHALL BE REPAIRED AT THE CONTRACTORS COST.

UNLESS THE PIPE STRENGTH CHARACTERISTICS HAVE BEEN COMPUTED AND APPROVED BY THE CONTRACTORS ENGINEER.

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450

TYPICAL RETAINING WALL DETAIL

(RETAINING WALL HEIGHT 1.0m)

NOT TO SCALE

600

SM2-M KERB DETAIL

SCALE 1:10

PROVIDE 100UC14.8 (C300)

1.5m MAX. SPACINGS

H.O. GALVANISED POSTS AT

PROVIDE CONCRETE SLEEPERS TO

REVISION

RETAINING WALL BLOCKED

BETWEEN POSTS

1300

THE FAIRWAYS

450

B2 KERB DETAIL

SCALE 1:10

60mm

A.Cantwell Checked M.Warry Authorised K.Taylor October 2020

Designed

Drawn

A.Cantwell

TACTILE PAVING DETAILS

NOT TO SCALE

Scale @ A1 N/A

Levels: AHD

Coords: MGA

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175 MCGLONE ROAD, DROUIN **DETAILED DESIGN - STAGE 4** BAW BAW SHIRE COUNCIL - PLA0382/16 ROADWORKS AND DRAINAGE **GENERAL NOTES & DETAILS**

Drawing No. 16028-04-09

Sheet No. 09 of 12

Rev 1



− − −H HOUSE DRAIN ——GW—— SERVICE CONDUITS TACTILE PAVERS ——Ex E—— EXISTING ELECTRICITY (UNDERGROUND) ——O/H E—— EXISTING ELECTRICITY (OVERHEAD) ——Ex G—— EXISTING GAS ——Ex T—— EXISTING TELSTRA ---Ex W--- EXISTING WATER ——EX RM—— EXISTING RISING MAIN ---EX RW--- EXISTING RECYCLED WATER Ex D— EXISTING STORMWATER DRAIN O—Ex S— EXISTING SEWER ---- EXISTING HOUSE DRAIN ---> ---> EXISTING SWALE DRAIN 141.34 EXISTING SURFACE LEVEL FS140.35 FINISHED BUILDING LINE LEVEL FR157.40 FINISHED RIDGE LINE LEVEL TW159.30 TOP OF RETAINING WALL BW159.30 BOTTOM OF RETAINING WALL RETAINING WALL — — ZERO LOT LINES PAVEMENT TREATMENT STRUCTURAL FILL > 200mm DEEP EX. STRUCTURAL FILL > 200mm DEEP OVERLAND FLOW * ALLOTMENT TO BE GRADED EVENLY IN DIRECTION OF FALL TO LEVELS INDICATED CONCRETE EDGE STRIP WITH SUBSOIL DRAIN, "NO ROAD" SIGN & BARRIER → LIMIT OF WORKS EXISTING TREE TO BE RETAINED/REMOVED ▲ PERMANENT SURVEY MARK TEMPORARY BENCH MARK PROPOSED DRIVEWAY → PROPOSED STREET LIGHT

<u>LEGEND - LAYOUT PLAN</u>

────── SWALE DRAIN

STORMWATER DRAIN, PIT & PROPERTY INLET

● S SEWER & MAINTENANCE STRUCTURES

			SERVICES OF	SET SCHEDULE					
DOAD NAME	C	iAS	WA	ATER	ELECT	RICITY	TELSTRA		
ROAD NAME	SIDE	OFFSET (m)	SIDE	OFFSET (m)	SIDE	OFFSET (m)	SIDE	OFFSET (m	
OPEN DRIVE (LOT 401)	EAST	1.80	EAST	2.30	EAST	3.30	EAST	2.80	
OPEN DRIVE (LOT 401-404)	SOUTH	2.10	SOUTH	2.60	NORTH	2.30	NORTH	1.80	
CART DRIVE (LOT 405-406)	FAST	2.10	FAST	2.60	WEST	2.30	WEST	1.80	

WARNING **BEWARE OF UNDERGROUND SERVICES** The locations of underground services are approximate only and their exact position should be proven on site. No guarantee is given that all existing services are shown. Locate all underground services before commencement of works **DIAL 1100 BEFORE YOU DIG** www.1100.com.au

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REVISION		DATE	DES/DFT	APP'D	

6.70

6.70

CLASSIFICATION

ACCESS ROAD

ACCESS ROAD

ACCESS ROAD

WIDTH (m)

14.00

16.00

16.00

ROAD NAME

OPEN DRIVE (LOT 401)

OPEN DRIVE (LOT 401-404)

CART DRIVE (LOT 405-406)

THE FAIRWAYS

STH/EAST

5.05

4.05

4.05

Seebo Properties Pty Ltd PO Box 342 Berwick, VIC, 3806

NTH/WEST

4.05

4.05

NTH/WEST

SM2-M

SM2-M

INV to INV BACK to BACK

7.30

7.30

7.30

7.75

7.90

7.90

STH/EAST


SM2-M

SM2-M



Date

October 2020

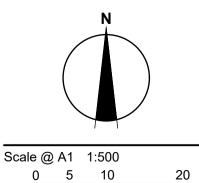

Coords: MGA

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Levels: AHD

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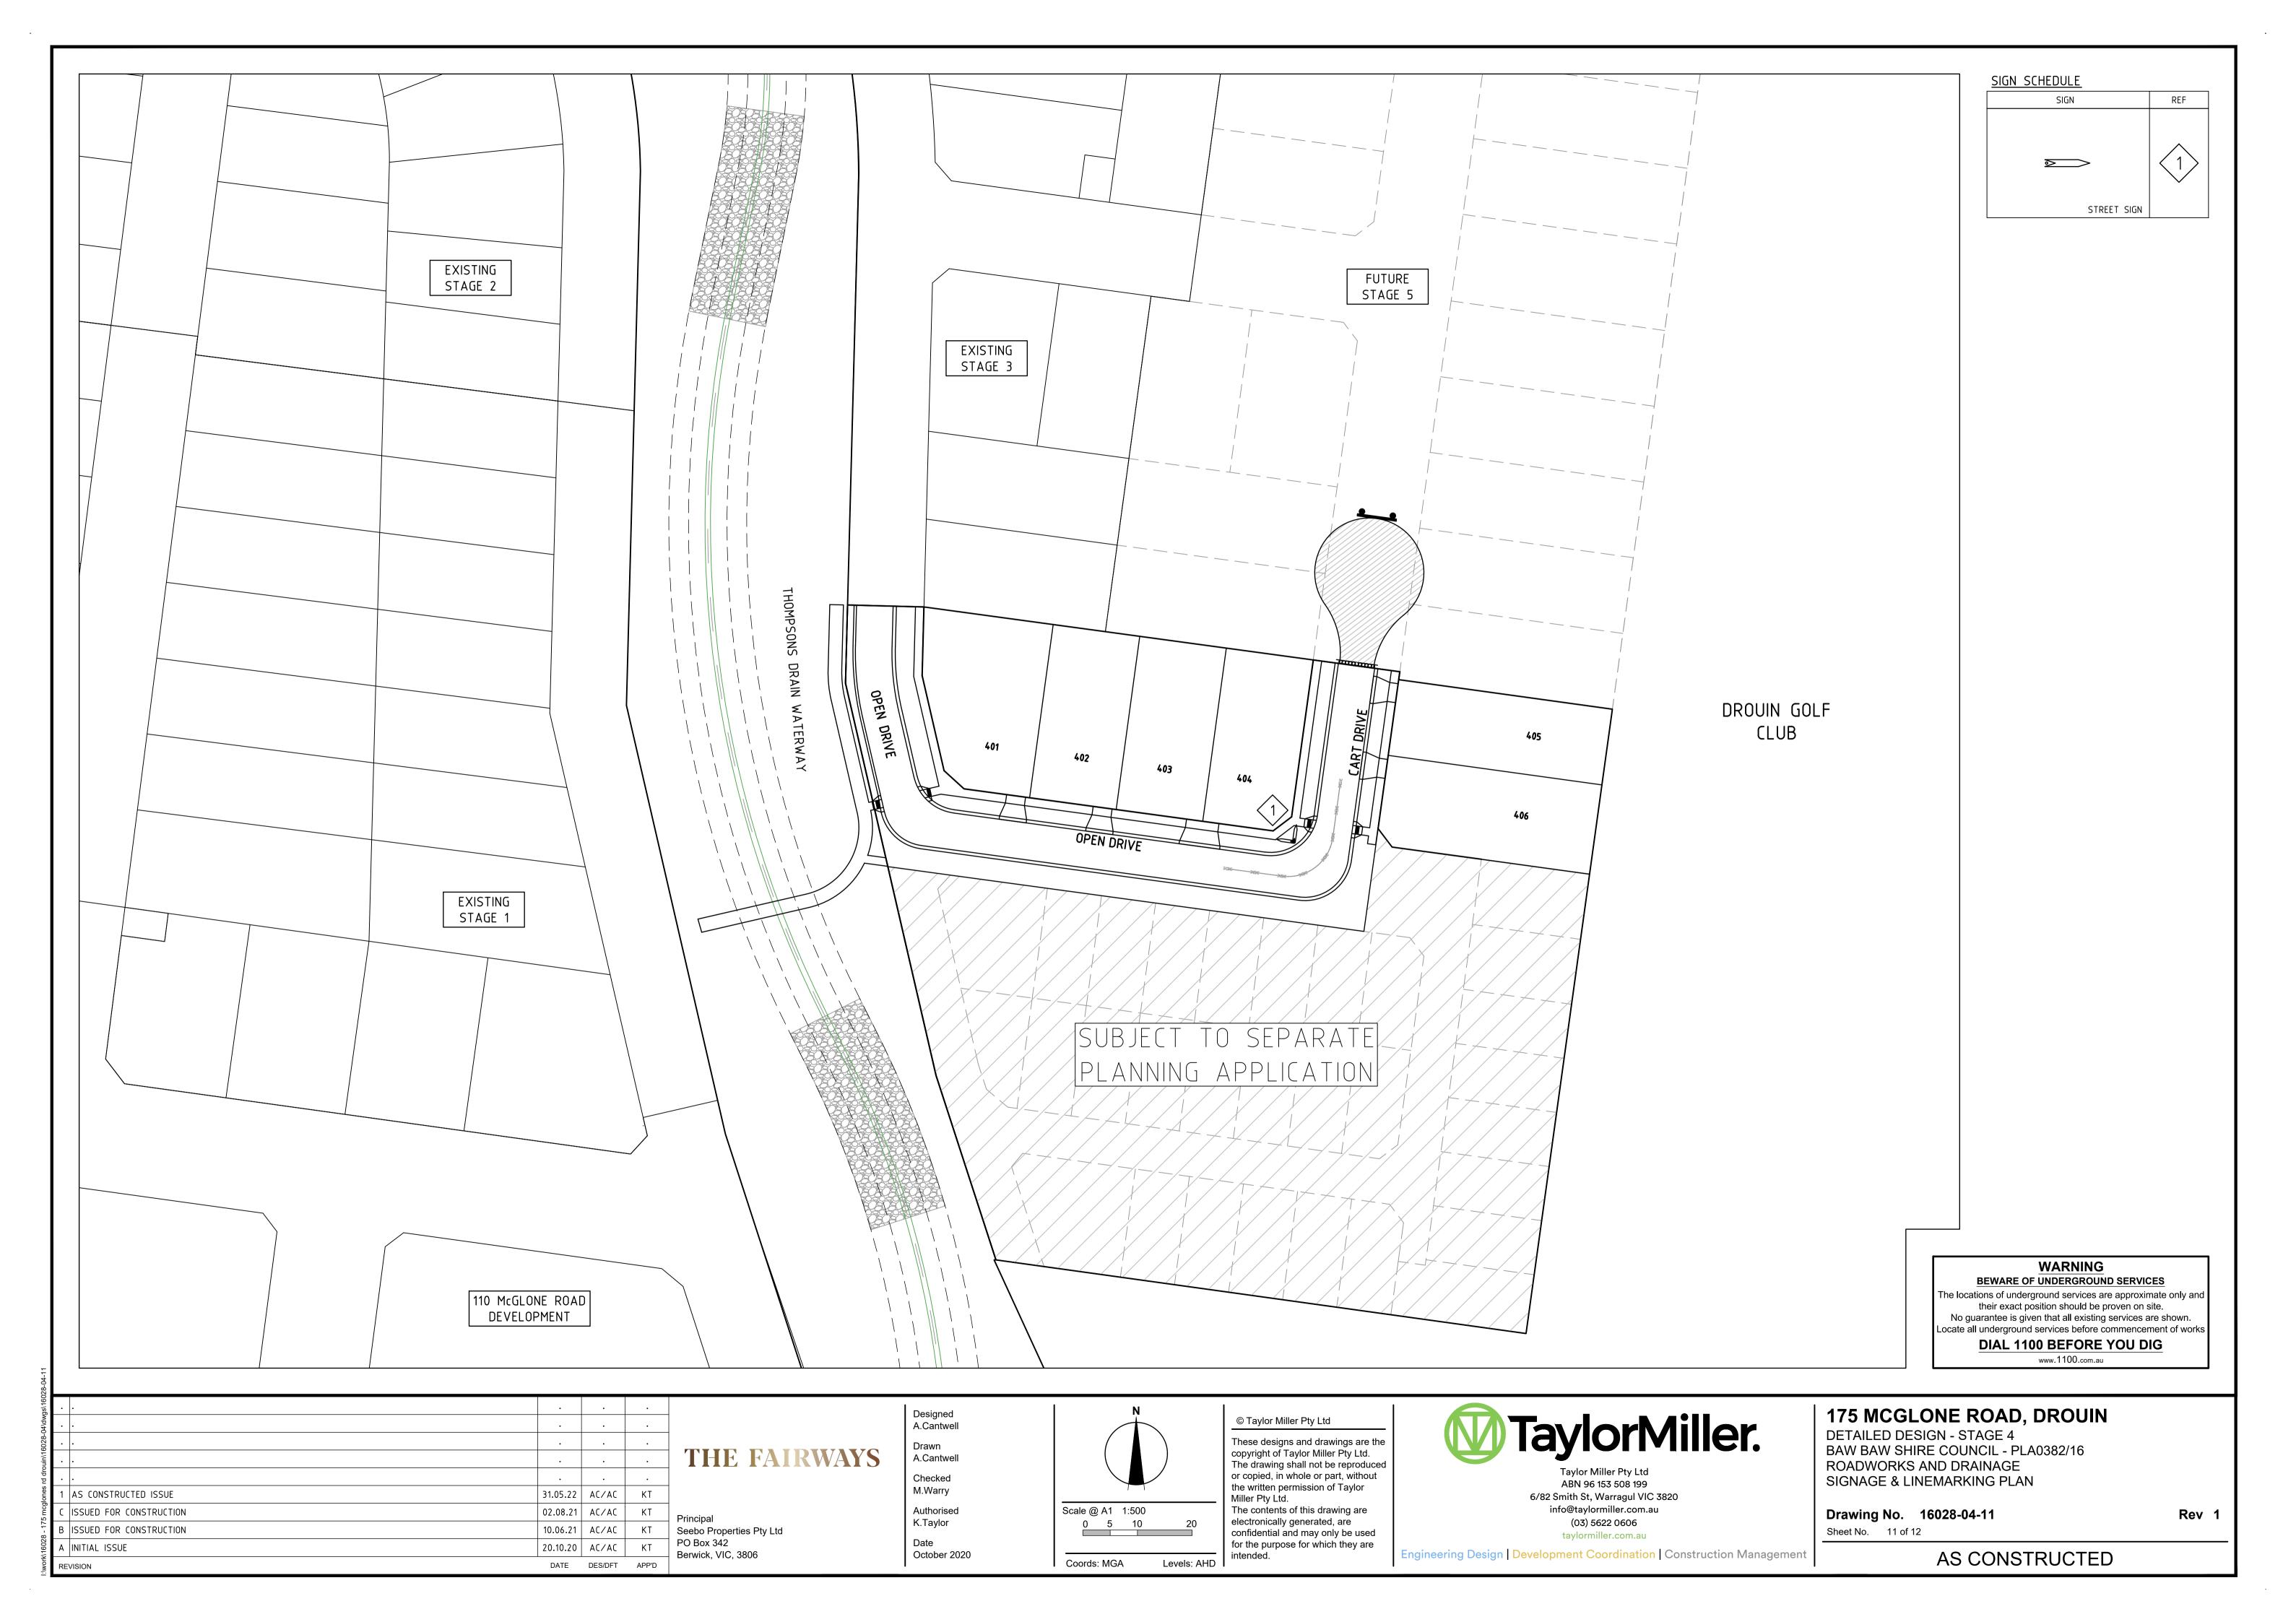
175 MCGLONE ROAD, DROUIN


DETAILED DESIGN - STAGE 4 BAW BAW SHIRE COUNCIL - PLA0382/16 ROADWORKS AND DRAINAGE MASTER SERVICES PLAN

Drawing No. 16028-04-10

Sheet No. 10 of 12

Rev 1



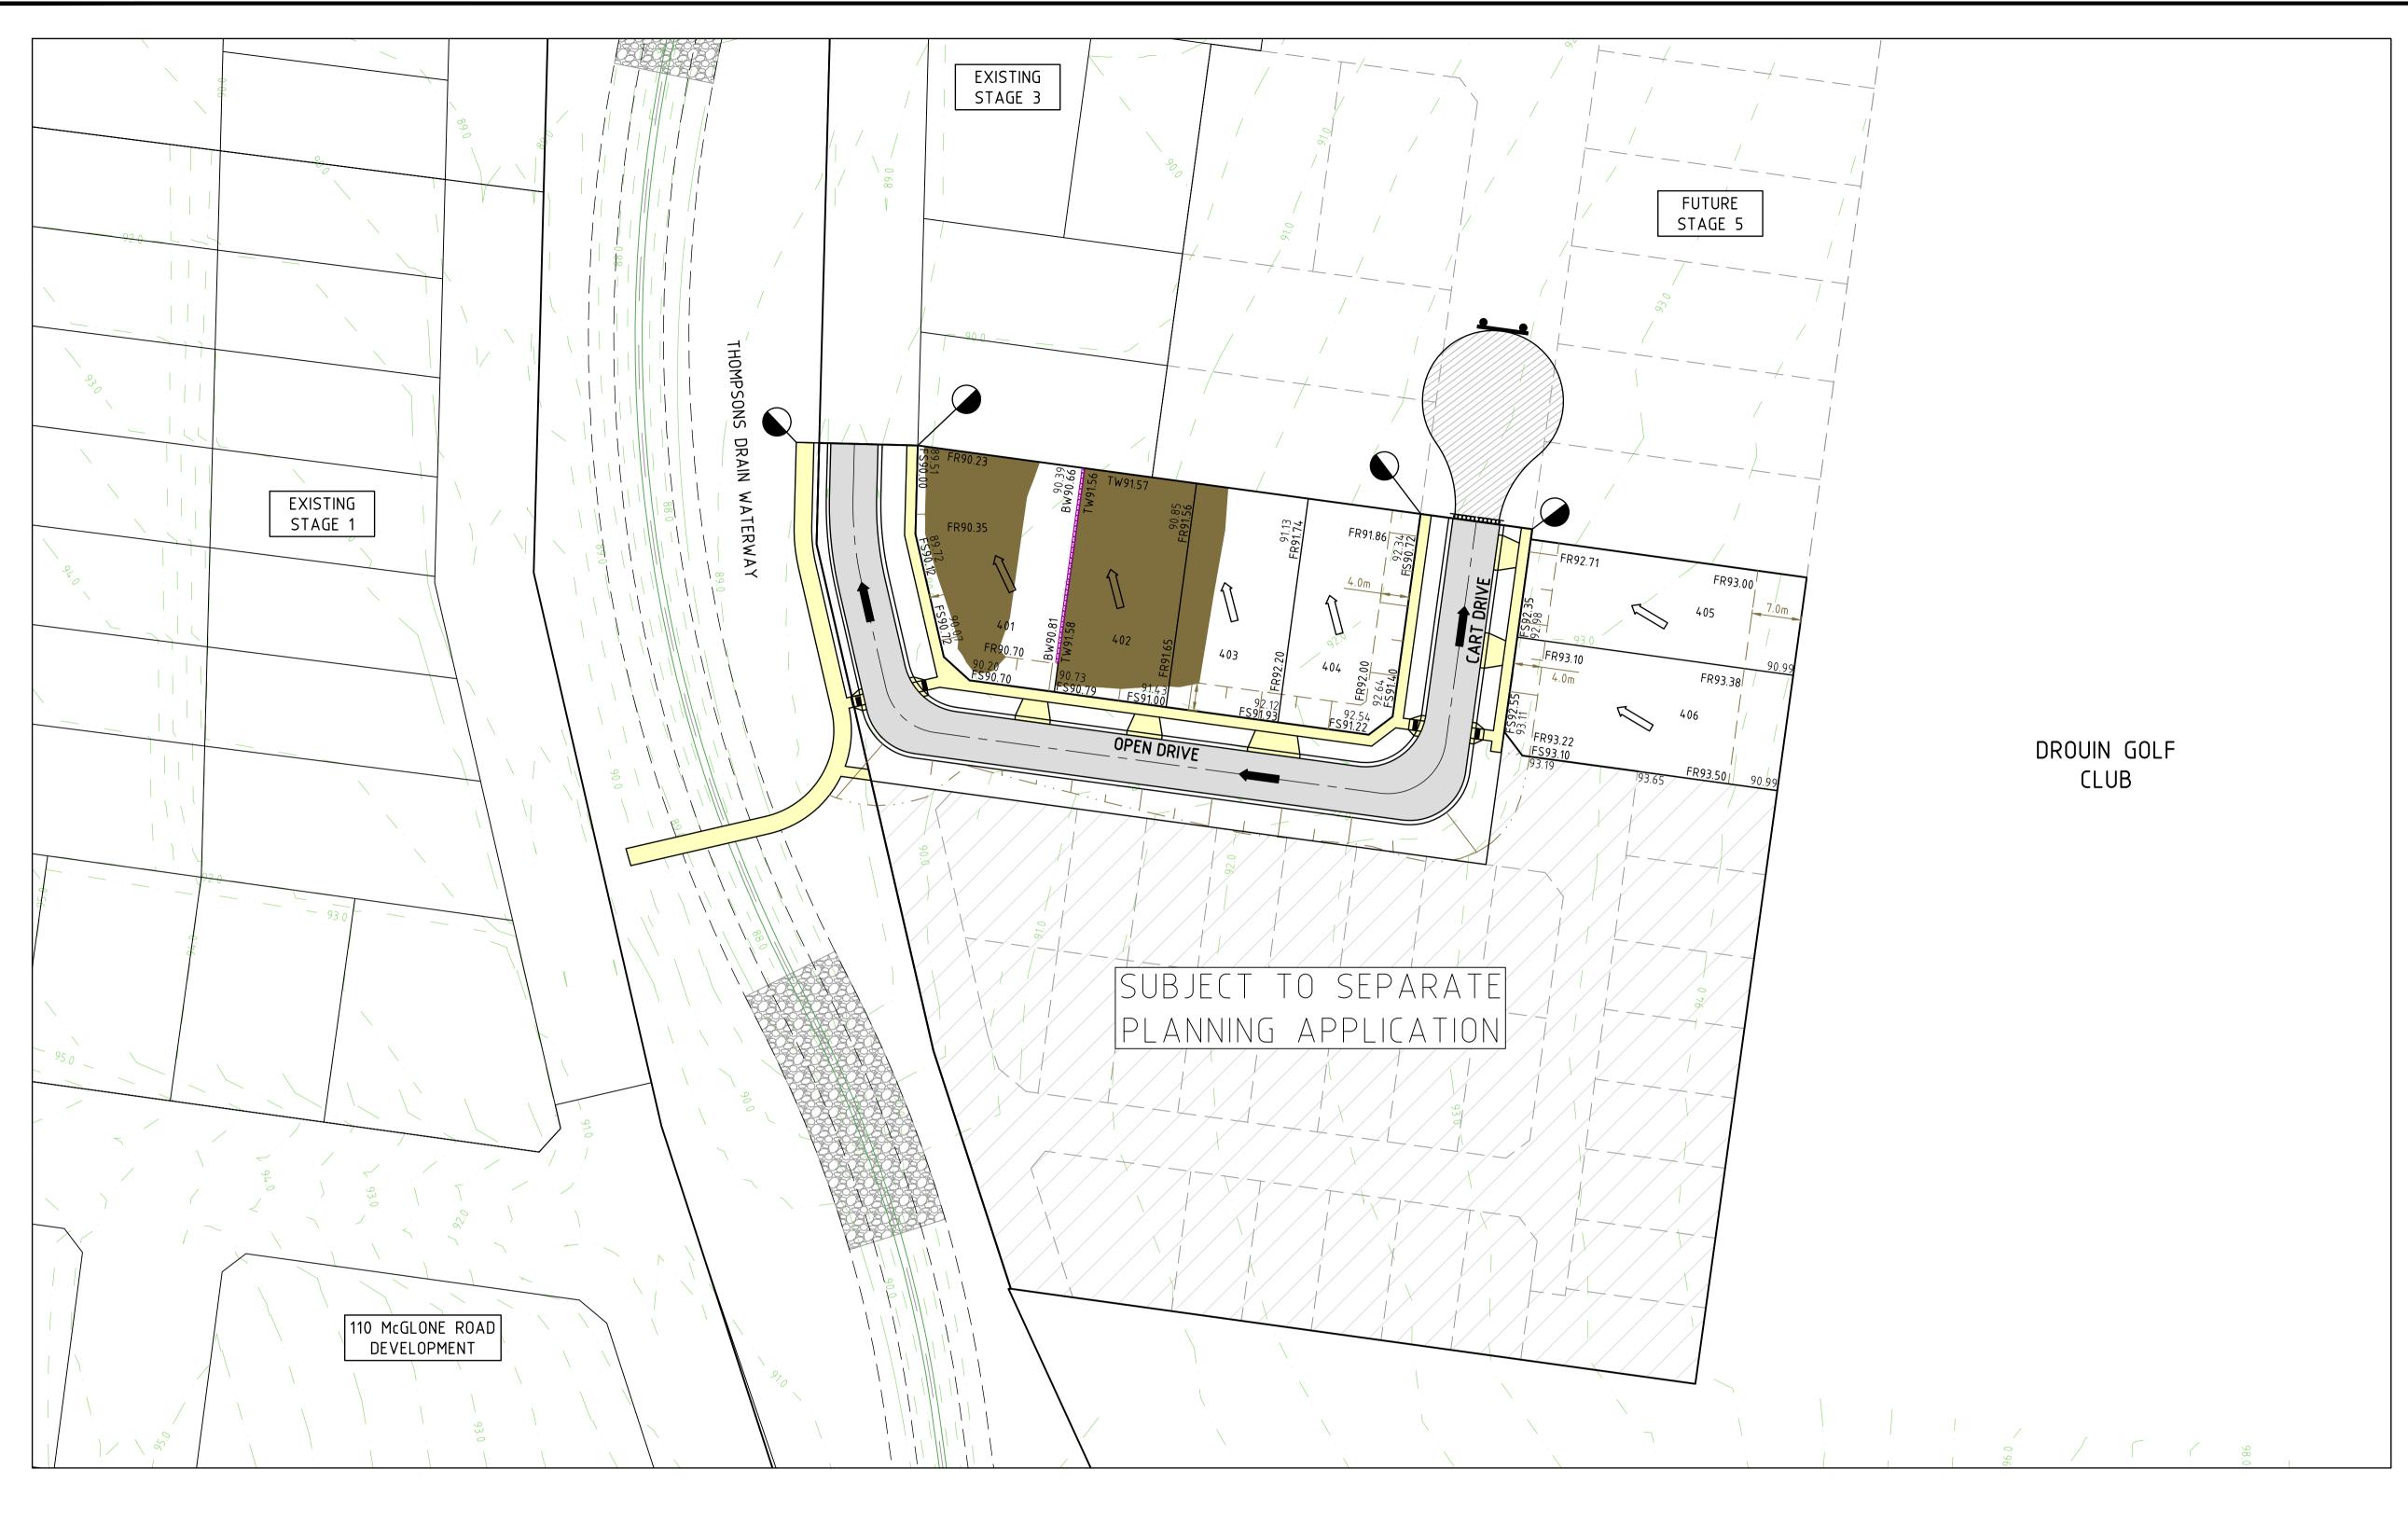

────── SWALE DRAIN SEWER & MAINTENANCE STRUCTURES − − −H HOUSE DRAIN ——GW— SERVICE CONDUITS TACTILE PAVERS ----Ex E---- EXISTING ELECTRICITY (UNDERGROUND) ---O/H E--- EXISTING ELECTRICITY (OVERHEAD) ---Ex G--- EXISTING GAS ---EX T--- EXISTING TELSTRA ---Ex W--- EXISTING WATER ——Ex RM—— EXISTING RISING MAIN ---Ex RW--- EXISTING RECYCLED WATER Ex D— EXISTING STORMWATER DRAIN O—Ex S— EXISTING SEWER ---- EXISTING HOUSE DRAIN ---> ---> EXISTING SWALE DRAIN 141.34 EXISTING SURFACE LEVEL FS140.35 FINISHED BUILDING LINE LEVEL FR157.40 FINISHED RIDGE LINE LEVEL TW159.30 TOP OF RETAINING WALL BW159.30 BOTTOM OF RETAINING WALL RETAINING WALL — — ZERO LOT LINES PAVEMENT TREATMENT STRUCTURAL FILL > 200mm DEEP EX. STRUCTURAL FILL > 200mm DEEP □□⇒ DIRECTION OF FALL OVERLAND FLOW * ALLOTMENT TO BE GRADED EVENLY IN DIRECTION OF FALL TO LEVELS INDICATED CONCRETE EDGE STRIP WITH SUBSOIL DRAIN, "NO ROAD" SIGN & BARRIER → LIMIT OF WORKS EXISTING TREE TO BE RETAINED/REMOVED A PERMANENT SURVEY MARK 人 TEMPORARY BENCH MARK PROPOSED DRIVEWAY
PROPOSED STREET LIGHT

<u>LEGEND - LAYOUT PLAN</u>

STORMWATER DRAIN, PIT & PROPERTY INLET

WARNING BEWARE OF UNDERGROUND SERVICES

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Locate all underground services before commencement of works

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A INITIAL ISSUE

THE FAIRWAYS

Principal
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Berwick, VIC, 3806

20.10.20 AC/AC


DATE DES/DFT

ΚT

Designed
A.Cantwell
Drawn
A.Cantwell
Checked
M.Warry
Authorised
K.Taylor

Date

October 2020

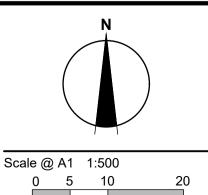

Levels: AHD

Coords: MGA

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175 MCGLONE ROAD, DROUIN

DETAILED DESIGN - STAGE 4
BAW BAW SHIRE COUNCIL - PLA0382/16
ROADWORKS AND DRAINAGE
RETAINING WALL & EARTHWORKS PLAN

Drawing No. 16028-04-12 Sheet No. 12 of 12

Rev 1

